
# COLLIER COUNTY, FLORIDA NORTH COUNTY WATER RECLAMATION FACILITY EQ ODOR CONTROL - PHASE II

SECTION 35, TOWNSHIP 48 SOUTH, RANGE 27 EAST PARCEL ID NO. 167840006 - ZONING DESIGNATION INDUSTRIAL, ORD 92-52 COLLIER COUNTY EPMD PROJECT #70148.12.4.2 **INSUBSTANTIAL CHANGE TO PL20120001111** 

		SHEET INDEX	
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32	I-703	PLC-8 MODIFICATIONS SCHEMATICS - II	
33	I-704	PLC-8 MODIFICATIONS SCHEMATICS - III	

# **COUNTY COMMISSIONERS:**

RICK LoCASTRO	DISTRICT 1
CHRIS HALL	
BURT L. SAUNDERS	
DAN KOWAL	
WILLIAM L. McDANIEL, JR	

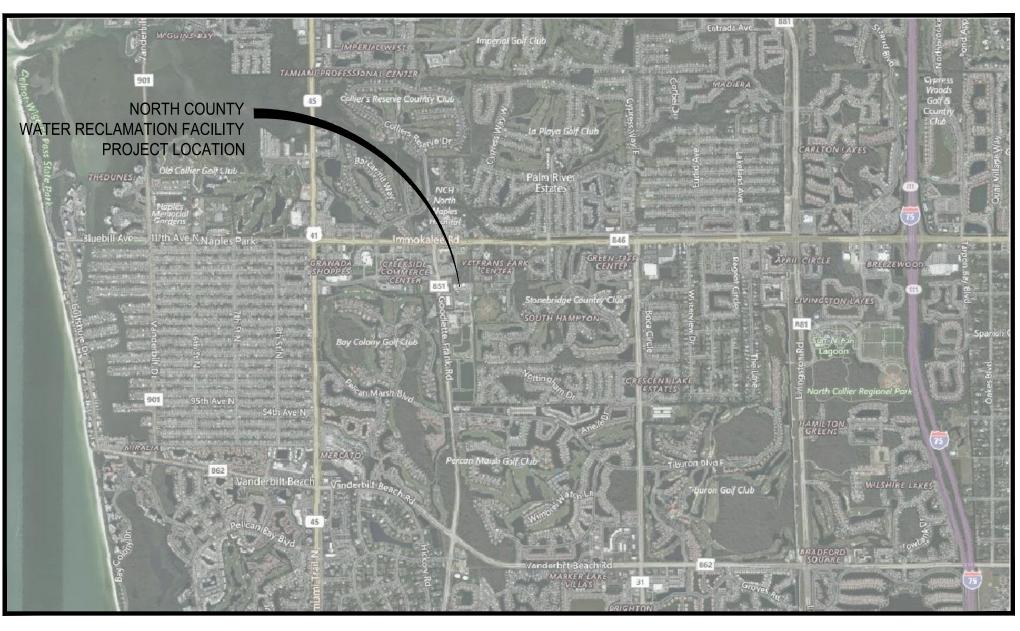



PLANS PREPARED FOR:





**Collier County Government** 33399 Tamiami Trail East Suite 303, Naples, FL 34112 Tel. (239) 252-8836 www.colliergov.net

3510 Kraft Road, Suite 200 Naples, FL U.S.A. 34105-5029 Tel. 239.649.4040 www.stantec.com

tantec

**BID SET** 

**FLORIDA** 

**PROJECT** 


LOCATION

Call before you dig.

Know what's below.

**SUNSHINE STATE ONE CALL OF** FLORIDA, INC.


STANTEC PROJECT NO. 177311697 NOVEMBER, 2023

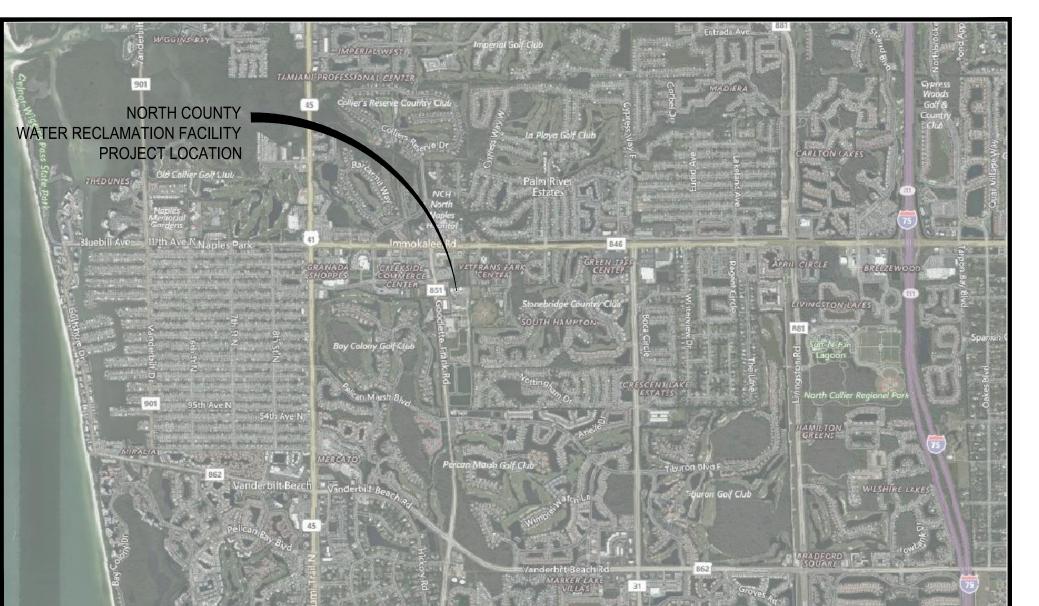

Stantec Consulting Services Inc.

Florida Certification No. 27013

**CALL 48 HOURS BEFORE YOU DIG IT'S THE LAW! DIAL 811** 

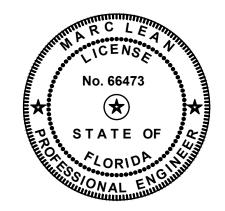

CIVIL: MARC LEAN, P.E. FLORIDA P.E. LICENSE NO. 66473


C-501

THIS ITEM HAS BEEN DIGITALLY SIGNED AND SEALED BY MARC LEAN, P.E. ON THE DATE ADJACENT TO THE SEAL.

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SHEET NUMBER	SHEET TITLE
G-001	COVER AND INDEX SHEET
G-002	SIGNATURE SHEET
G-003	GENERAL NOTES AND ABBREVIATIONS
C-101	EXISTING CONDITIONS PLAN
C-102	DEMOLITION PLAN
C-103	PROPOSED SITE PLAN AND ASPHALT RESTORATION
C-104	STORMWATER POLLUTION PREVENTION PLAN
C-500	BEST MANAGEMENT PRACTICES

CIVIL DETAILS

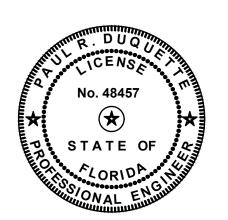


STUCTURAL:
PAUL R. DUQUETTE, P.E.
FLORIDA P.E. LICENSE NO. 48457

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SHEET NUMBER	SHEET TITLE

S-101	ODOR CONTROL EQUIPMENT PAD AND DUCT SUPPOR
S-102	SECTIONS AND DETAILS
S-103	ELEVATIONS AND DETAILS




MECHANICAL: HAROLD E. SCHMIDT JR, P.E. FLORIDA P.E. LICENSE NO. 38819 THIS ITEM HAS BEEN DIGITALLY SIGNED AND SEALED BY HAROLD E. SCHMIDT JR, P.E. ON THE DATE ADJACENT TO THE SEAL.
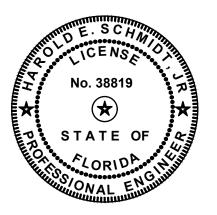
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SHEET NUMBER	SHEET TITLE
OTTEET HOMBER	

M-101 MECHANICAL PLAN AND SECTION VIEW

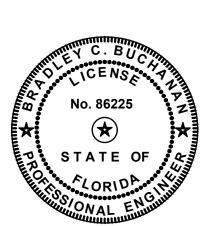

ELECTRICAL: BRADLEY C. BUCHANAN, P.E. FLORIDA P.E. LICENSE NO. 86225 THIS ITEM HAS BEEN DIGITALLY SIGNED AND SEALED BY BRADLEY C. BUCHANAN, P.E. ON THE DATE ADJACENT TO THE SEAL.

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SHEET NUMBER	SHEET TITLE

E-001 E-002 E-003 E-101 E-102 E-103 E-401 E-501 E-502 E-601 E-602 E-603 E-604 I-001 I-601 I-602 I-701	ELECTRICAL GENERAL NOTES, LEGENDS, AND ABBREVIATIONS ELECTRICAL GENERAL NOTES, LEGENDS, AND ABBREVIATIONS ELECTRICAL GENERAL NOTES, LEGENDS, AND ABBREVIATIONS ELECTRICAL DEMOLITION ELECTRICAL SITE PLAN ELECTRICAL GROUNDING AND LIGHTNING PROTECTION ELECTRICAL COORDINATION NOTES ELECTRICAL TYPICAL DETAILS ELECTRICAL TYPICAL DETAILS ELECTRICAL TYPICAL DETAILS ELECTRICAL ONE LINE DIAGRAMS MCC-12A/12B ELECTRICAL ELEVATION AND LOAD CALC MCC-12A/12B TYPICAL EXHAUST FAN STARTER SCHEMATIC KEY INTERLOCK PROCEDURE INSTRUMENTATION AND CONTROLS GENERAL NOTES, LEGENDS AND ABBREVIATIONS INSTRUMENTATION AND CONTROLS CARBON SCRUBBER P&ID INSTRUMENTATION AND CONTROLS TYPICAL LOOP DIAGRAMS PLC-8 MODIFICATIONS LAYOUT PLC-8 MODIFICATIONS SCHEMATIC - I
I-703	PLC-8 MODIFICATIONS SCHEMATICS - II
I-704	PLC-8 MODIFICATIONS SCHEMATIC - III



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Client/Project Logo



NOTES:

Revision		Ву	Appd	Date
Issued		ML By	SM N	Date
File Name: 11697-G-002	MPL Dwn.	ML Dsgn.	SM N	NOVEMBER, 2023 Date

Permit/Seal

MARC LEAN, PE 66473

Client/Project
COLLIER COUNTY PUBLIC UTILITIES

NORTH COUNTY WATER RECLAMATION FACILITY ODOR CONTROL - PHASE II

Title

SIGNATURE SHEET

Project No.	Scale
177311697	
Phase	Drawing No.

BID SET 2 of 33

G-002


ORIGINAL SHEET - ANSI D

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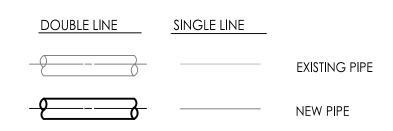
# GENERAL NOTES


- ALL MATERIALS AND CONSTRUCTION METHODS USED FOR THE PROPOSED IMPROVEMENTS SHALL CONFORM WITH THE COLLIER COUNTY LAND DEVELOPMENT CODE, THE COLLIER COUNTY WATER - SEWER DISTRICT UTILITIES STANDARDS MANUAL, THE APPROVED SUPPLEMENTAL TECHNICAL STANDARDS AND SPECIFICATIONS, AND ALL FEDERAL, STATE, AND LOCAL REGULATIONS. IN THE CASE OF A CONFLICT, THE MORE STRINGENT REQUIREMENT THAT RESULTS IN A HIGHER QUALITY FINISHED PRODUCT SHALL GOVERN.
- ALL MATERIALS SUPPLIED SHALL CONFORM TO THE PLANS AND SPECIFICATIONS, AS WELL AS SHOP DRAWINGS AS APPROVED BY ENGINEER PRIOR TO CONSTRUCTION. SUBSTITUTE MATERIALS SHALL NOT BE APPROVED AFTER DELIVERY TO THE JOB SITE. ALL REQUESTS FOR MATERIAL SUBSTITUTION SHALL BE APPROVED PRIOR TO DELIVERY OF THESE MATERIALS TO THE JOB SITE.
- THE CONTRACTOR SHALL BE RESPONSIBLE AT ALL TIMES THROUGH THE DURATION OF CONSTRUCTION FOR THE PROTECTION OF EXISTING AND NEWLY INSTALLED UTILITIES FROM DAMAGE OR DISRUPTION OF SERVICE. THE CONTRACTOR SHALL BE RESPONSIBLE FOR TAKING SUCH MEASURES AS NECESSARY TO PROTECT THE HEALTH, SAFETY, AND WELFARE OF THOSE PERSONS HAVING ACCESS TO THE WORK SITE,
- 4. ELEVATIONS ARE REFERENCED TO THE NORTH AMERICAN VERTICAL DATUM OF 1988. NAVD 88, (+1.23') to = NGVD 29.
- THE HORIZONTAL DATUM IS THE FLORIDA STATE PLANE COORDINATE SYSTEM, EAST ZONE, NORTH AMERICAN DATUM 1983 (2011).
- LOCATIONS, ELEVATIONS AND DIMENSIONS OF EXISTING UTILITIES, STRUCTURES AND OTHER FEATURES ARE SHOWN ACCORDING TO THE BEST INFORMATION AVAILABLE AT THE TIME OF THE PREPARATION ON THESE PLANS BUT DOES NOT PURPORT TO BE ABSOLUTELY CORRECT. THE CONTRACTOR SHALL VERIFY THE LOCATIONS, ELEVATIONS AND DIMENSIONS OF ALL EXISTING UTILITIES AND OTHER FEATURES AFFECTING THIS WORK PRIOR TO COMMENCING ANY CONSTRUCTION ACTIVITY.
- CONTRACTOR SHALL BE RESPONSIBLE FOR OBTAINING ALL APPLICABLE PERMITS BEFORE COMMENCING WORK.
- 8. CONTRACTOR SHALL BE RESPONSIBLE FOR REPAIRING OR REPLACING AND REMOVING AND DISPOSING ANY DAMAGED ITEMS INCLUDING, BUT NOT LIMITED TO DRIVEWAYS, SIDEWALKS, BOLLARDS, SIGNS, STORM CULVERTS, FENCES AND LANDSCAPING AS REQUIRED BY OWNER, ENGINEER OF RECORD, AND/OR OTHER GOVERNING ENTITIES.
- 9. ALL DISTURBED AREAS SHALL BE RESTORED, INCLUDING REGRADING, TO THEIR ORIGINAL CONDITION OR BETTER UNLESS OTHERWISE NOTED.
- 10. CONTRACTOR SHALL BE RESPONSIBLE FOR REGRADING AND REPLANTING VEGETATION IN ALL AREAS DISTURBED BY THE CONSTRUCTION.
- 11. CONTRACTOR SHALL PROVIDE ALL LABOR, EQUIPMENT, TOOLS, MATERIALS AND SERVICES NEEDED TO ENSURE ADEQUATE EROSION AND SEDIMENT CONTROL MEASURES. THESE MEASURES SHALL CONFORM TO THE PLANS AND SPECIFICATIONS AND ALL STATE AND LOCAL REQUIREMENTS.
- 12. ANY DISCREPANCIES IN THE DRAWINGS AND/OR SPECIFICATIONS SHALL BE BROUGHT TO THE ATTENTION OF THE COUNTY IN WRITING BEFORE BIDDING OR COMMENCING WORK.
- 13. NO FIELD CHANGES OR DEVIATION FROM DESIGN SHALL BE MADE WITHOUT PRIOR APPROVAL OF THE COUNTY IN WRITING.
- 14. NO CONNECTION TO, OR ANY OTHER CONSTRUCTION SHALL BE PERFORMED ON AN EXISTING UTILITY MAIN OR STRUCTURE WITHOUT THE PRESENCE OF A COLLIER COUNTY UTILITY INSPECTOR.
- 15. CONTRACTOR SHALL BE RESPONSIBLE FOR MAINTAINING TRAFFIC AND USAGE OF THE EXISTING STREETS ADJACENT TO THE PROJECT. ALL TRAFFIC MAINTENANCE CONTROLS SHALL BE IN ACCORDANCE WITH FLORIDA MANUAL OF TRAFFIC CONTROL AND SAFE PRACTICES FOR STREET CONSTRUCTION, MAINTENANCE, AND UTILITY OPERATIONS.
- 16. CONTRACTOR SHALL CONFIRM LIMITS OF STAGING AREA WITH PLANT MANAGER.
- 17. EXCAVATIONS MUST MEET OSHA REQUIREMENTS AND CONTRACTOR SHALL CONFORM TO THE GUIDELINES SET FORTH IN THE FLORIDA TRENCH SAFETY ACT THROUGHOUT THE DURATION OF THE PROJECT. CONTRACTOR SHALL PROVIDE WRITTEN ASSURANCE THAT THE TRENCH EXCAVATION WILL COMPLY WITH THE APPLICABLE TRENCH SAFETY STANDARDS.
- 18. COLLIER COUNTY PUBLIC UTILITIES DEPARTMENT WILL BE RESPONSIBLE FOR MAINTENANCE OF INFRASTRUCTURE PROPOSED ON THIS PROJECT, WITHIN THE SITE, INCLUDED OPEN SPACE, PAVED AREAS, ETC.
- 19. COLLIER COUNTY PUBLIC UTILITIES DEPARTMENT IS RESPONSIBLE FOR MAINTENANCE OF EXISTING WATER MANAGEMENT FACILITIES WITHIN THE FACILITY.
- 20. THE APPROVAL OF THESE CONSTRUCTION PLANS DOES NOT AUTHORIZE CONSTRUCTION OF REQUIRED IMPROVEMENTS WHICH ARE INCONSISTENT WITH EASEMENT OF RECORD.

# DRAFTING LEGEND

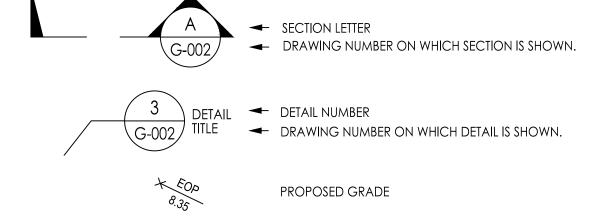

# SYMBOLS LEGEND



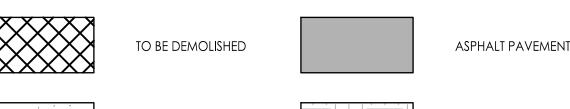



**EXISTING GRASS** 

PROPOSED CONCRETE

# **ABBREVIATIONS**

ABN	ABANDONED OR ABANDON
AL, ALUM.	ALUMINUM
APPROX.	APPROXIMATE
BE	BURIED ELECTRICAL
B.F., BF	BLIND FLANGE
	BUILDING
BLDG. CI	
	CAST IRON
C/L	CENTERLINE
CONC	CONCRETE
DBC	DUCT BANK
DET	DETAIL
DIA.	DIAMETER
DIP OR DI	DUCTILE IRON PIPE
DR	DRAIN
DWG.	DRAWING
EFF.	EFFLUENT
ELECT.	ELECTRIC
EL, ELEV.	ELEVATION
EOP	EDGE OF PAVEMENT
EQUIP.	EQUIPMENT
EXIST.	EXISTING
FD	FLOOR DRAIN
FRP	FIBERGLASS REINFORCED PLASTIC
ID	INSIDE DIAMETER
INFL	INFLUENT
INV	INVERT
MANUF	MANUFACTURER
MAX	MAXIMUM
MECH	MECHANICAL
N/A	NOT APPLICABLE
MIN	MINIMUM
NO	NUMBER
NTS	NOT TO SCALE
PVC	POLYVINYL CHLORIDE PIPE
RD	ROOF DRAIN
REQ'D	REQUIRED
SCH	SCHEDULE
SECT	SECTION
SHT	SHEET
SPEC	SPECIFICATION
SS	SANITARY SEWER, STAINLESS STEEL
STL	STEEL
TBA	TO BE ABANDONED
TBR	TO BE REMOVED
TYP	TYPICAL
UNK	UNKNOWN
WM	WATER MAIN

**EXISTING VALVE SYMBOLS** 

→ BALL CHECK

——— CONTROL


MUD

— IN-LINE PRESSURE RELIEF


ANGLE PRESSURE RELIEF

ANGLE BACKPRESSURE

NEW MOTOR OPERATOR TO BE INSTALLED. HANDWHEEL ORIENTED IN DIRECTION SHOWN

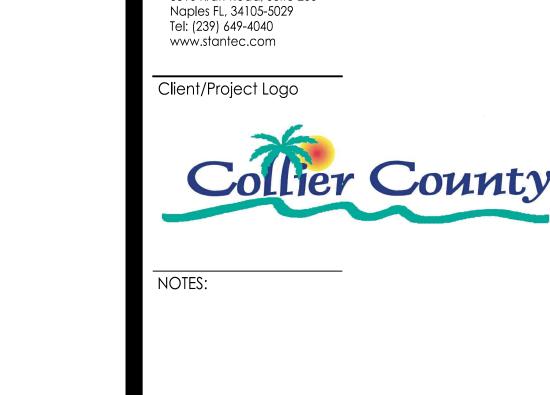

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Permit/Seal

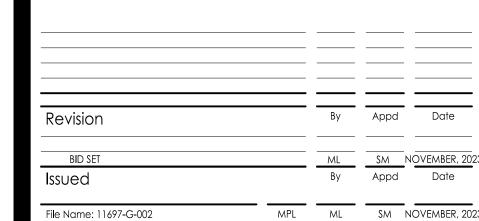MARC LEAN, PE

Client/Project COLLIER COUNTY PUBLIC UTILITIES

NORTH COUNTY WATER RECLAMATION FACILITY ODOR CONTROL - PHASE II

GENERAL NOTES AND ABBREVIATIONS


Scale Project No. **AS SHOWN** 177311697 Phase Drawing No.

**BID SET** 3 of 33 G-003

66473

# **EXISTING LINETYPE**

#### CENTERLINE WATER MAIN \_\_\_\_ \_\_ WM \_\_\_ \_\_ \_\_ WM \_\_\_ \_\_ FORCE MAIN — FM — — FM — — ELECTRIC BURIED POWER — BP — — BP — — PLANT SERVICE WATER — — PSW — — — PSW — — CLARIFIER EFFLUENT — — CE — — CE — — RECLAIMED WATER — RCW — — RCW — —

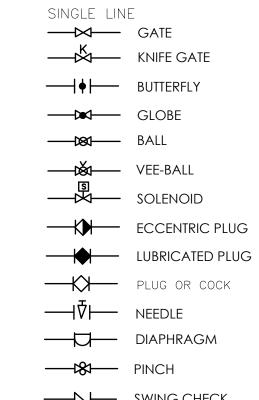


— SWING CHECK ——— DOUBLE LEAF CHECK


# **SURVEY NOTES**

TOPOGRAPHIC SURVEY PROVIDED BY AIM ENGINEERING & SURVEYING, INC. AIM PROJECT NUMBER 21-1416 PHASE 300, DATED SEPTEMBER 14, 2022.

PROPOSED ASPHALT PAVEMENT

- 2. SUBSURFACE UTILITY ENGINEERING TEST HOLE DATA PROVIDED BY AIM ENGINEERING & SURVEYING, INC. DATED DECEMBER 27, 2021 TO JUNE 16, 2022. HORIZONTAL DATUM: FLORIDA STATE PLANE, EAST ZONE, NAD 83. VERTICAL DATUM: NAVD 88 (NATIONAL GEODETIC VERTICAL DATUM) 1988.
- 3. NCWRF FLOW EQUALIZATION SYSTEM, PHASE 2 RECORD DRAWINGS, DATED JANUARY 2006, PREPARED BY HAZEN AND SAWYER AND HOLE MONTES.

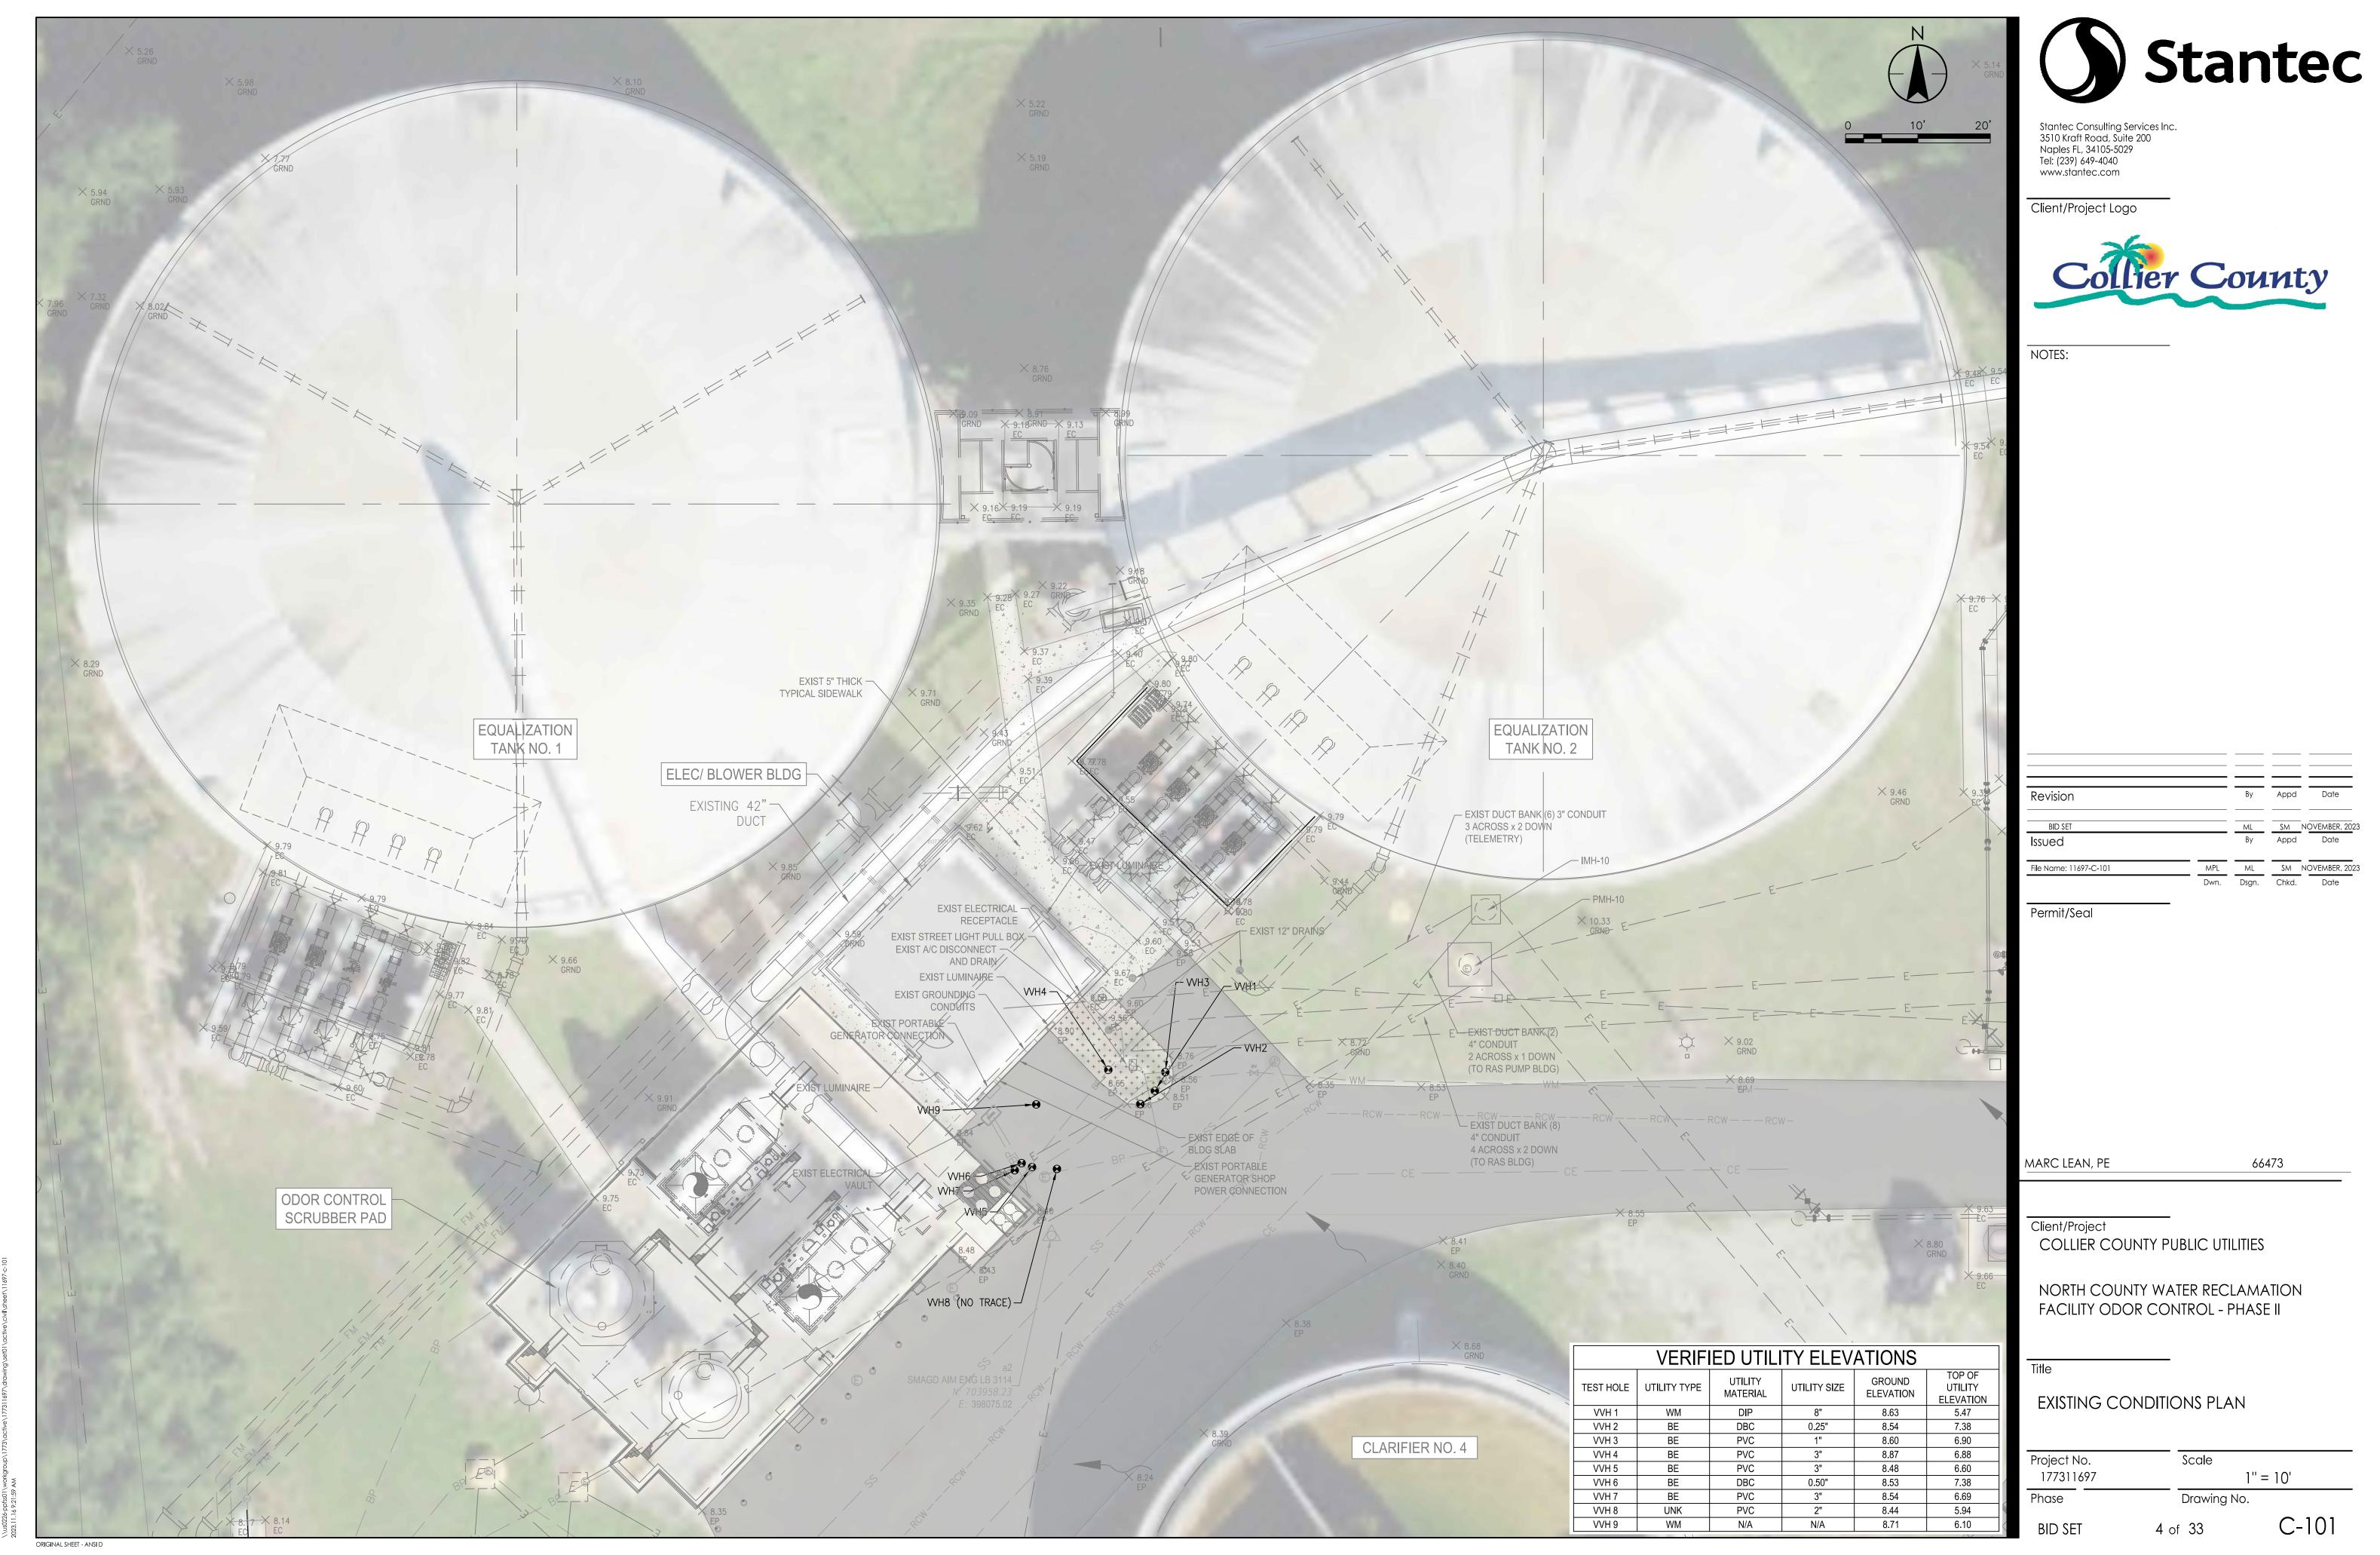

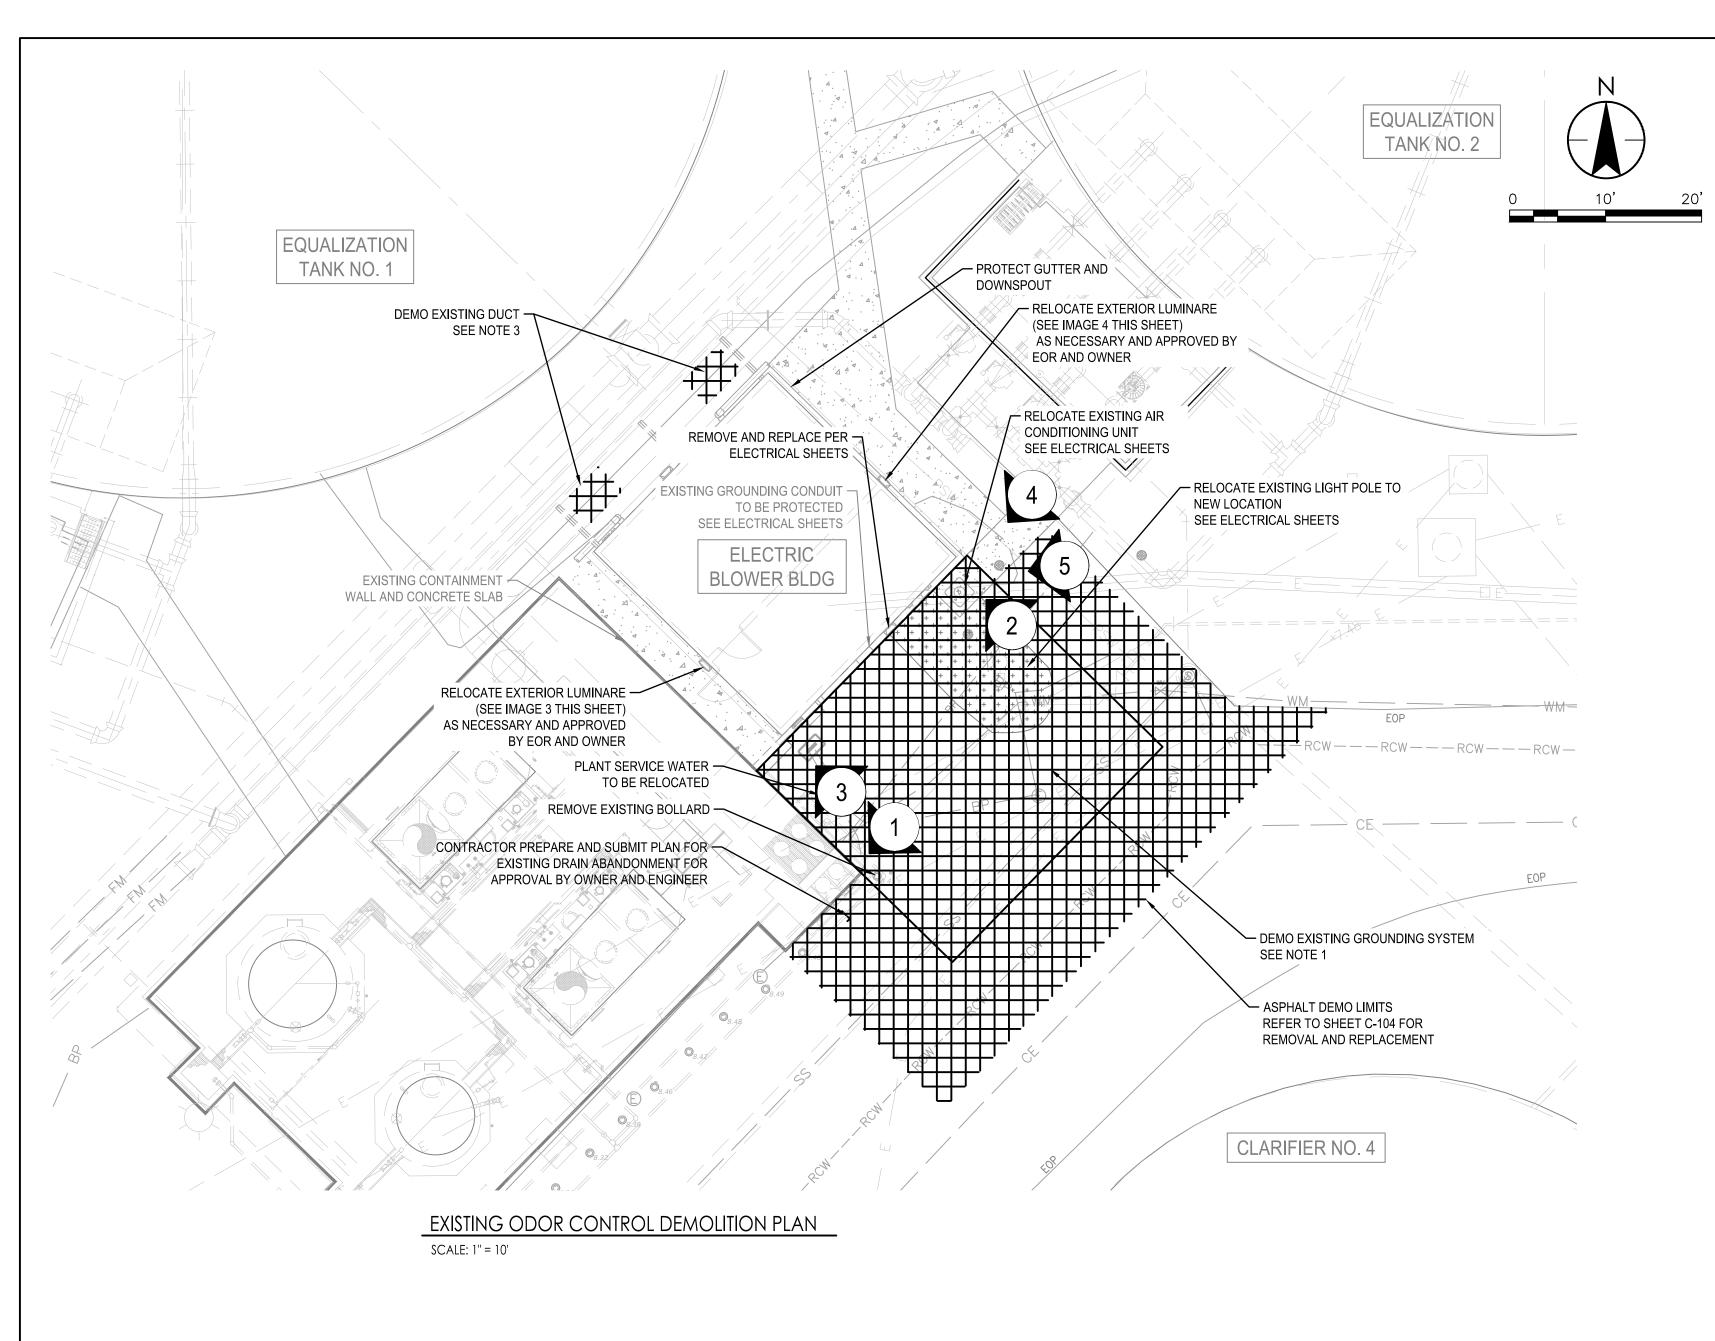

SUPPORT BRACKET, IF NECESSARY AS APPROVED BY EOR AND OWNER

> DEMOLISH AND REMOVE BOTTOM CONCRETE STEP

XISTING CONTAINMENT WALL

AND CONCRETE SLAB TO REMAIN


PROPOSED SLAB AND ABANDON

CONTAINMENT DRAIN PIT PIPING

WEST ELEVATION

- EXISTING HANDRAIL TO REA PLANT SERVICE WATER TO BE - CAP BELOW BOTTOM OF PROPOSED SLAB AND ABANDON CONTAINMENT DRAIN PIT PIPING - EXISTING CONTAINMENT WALL AND CONCRETE SLAB TO REMAIN DEMOLISH AND REMOVE DEMOLISH AND REMOVE -EXISTING BOLLARD BOTTOM CONCRETE STEP


**EXISTING CONTAINMENT WALL** 

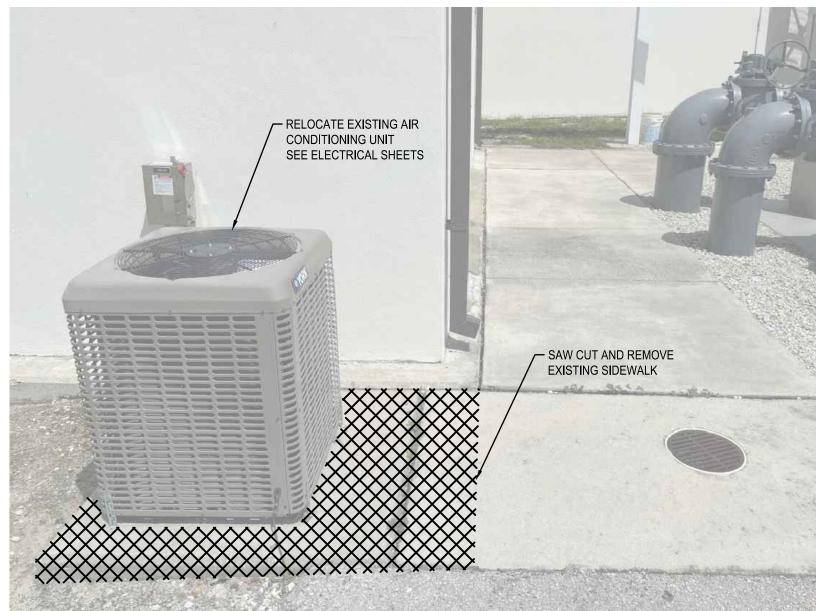

EXISTING A/C UNIT



EAST ELEVATION

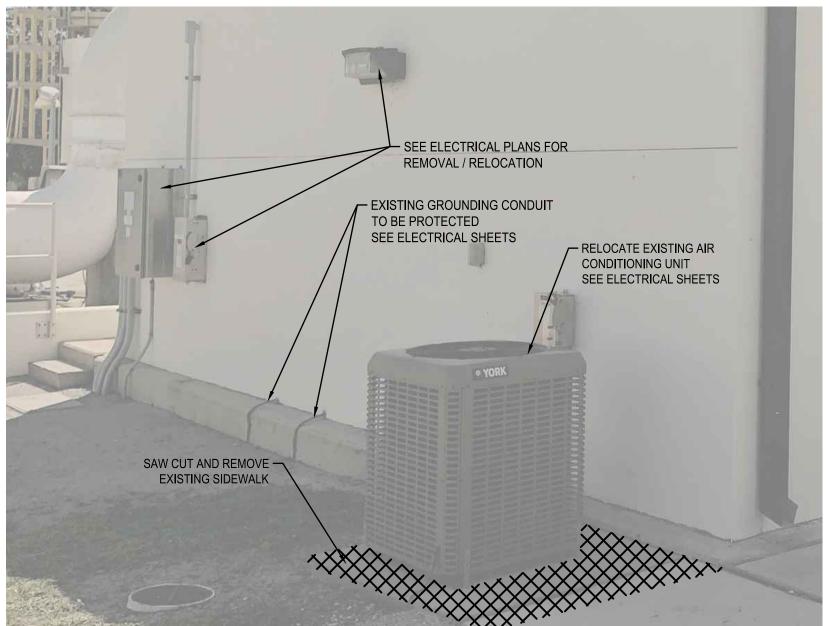

SOUTH ELEVATION



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- SEE KEY NOTE 3 ON E-101 FOR EXISTING GROUNDING SYSTEM DEMOLITION.
- ALL EXTERIOR FACADE, DOORS, GUTTERS, DOWNSPOUTS, FASCIA, MECHANICAL LOUVERS, PROCESS PIPING, RAILING, AND BUILDING ELECTRICAL APPURTENANCES TO BE PROTECTED UNLESS OTHERWISE
- CONTRACTOR SHALL STABILIZE EXISTING DUCT WHILE CONDUCTING INSTALLATION ACTIVITIES. PORTION OF DUCT THAT IS CUT SHALL BE REMOVED AND DISPOSED OF BY THE CONTRACTOR. CONTRACTOR SHALL CUT EXISTING FRP DUCT FOR CONNECTION TO PROPOSED DUCT WORK. CONTRACTOR SHALL COORDINATE WITH PLANT MANAGER ON OPERATION OF EXISTING CHEMICAL SCRUBBER #1 AND #2.
- FILL ALL EXISTING CMU PENETRATIONS WITH NON-SHRINK GROUT, THEN APPLY STUCCO FINISH AND PINT TO MATCH EXISTING

Revision		Ву	Appd	Date
BID SET Issued		ML By	SM N	N <mark>OVEMBER, 20</mark> 23 Date
File Name: 11697-C-102	MPL Dwn.	ML Dsgn.		NOVEMBER, 2023

Permit/Seal

MARC LEAN, PE

66473

Client/Project COLLIER COUNTY PUBLIC UTILITIES

NORTH COUNTY WATER RECLAMATION FACILITY ODOR CONTROL - PHASE II

DEMOLITION PLAN

Scale Project No. AS SHOWN 177311697 Drawing No. Phase


5 of 33 **BID SET** 


C-102


ORIGINAL SHEET - ANSI D

DEMOLISH AND REMOVE -

EXISTING BOLLARD

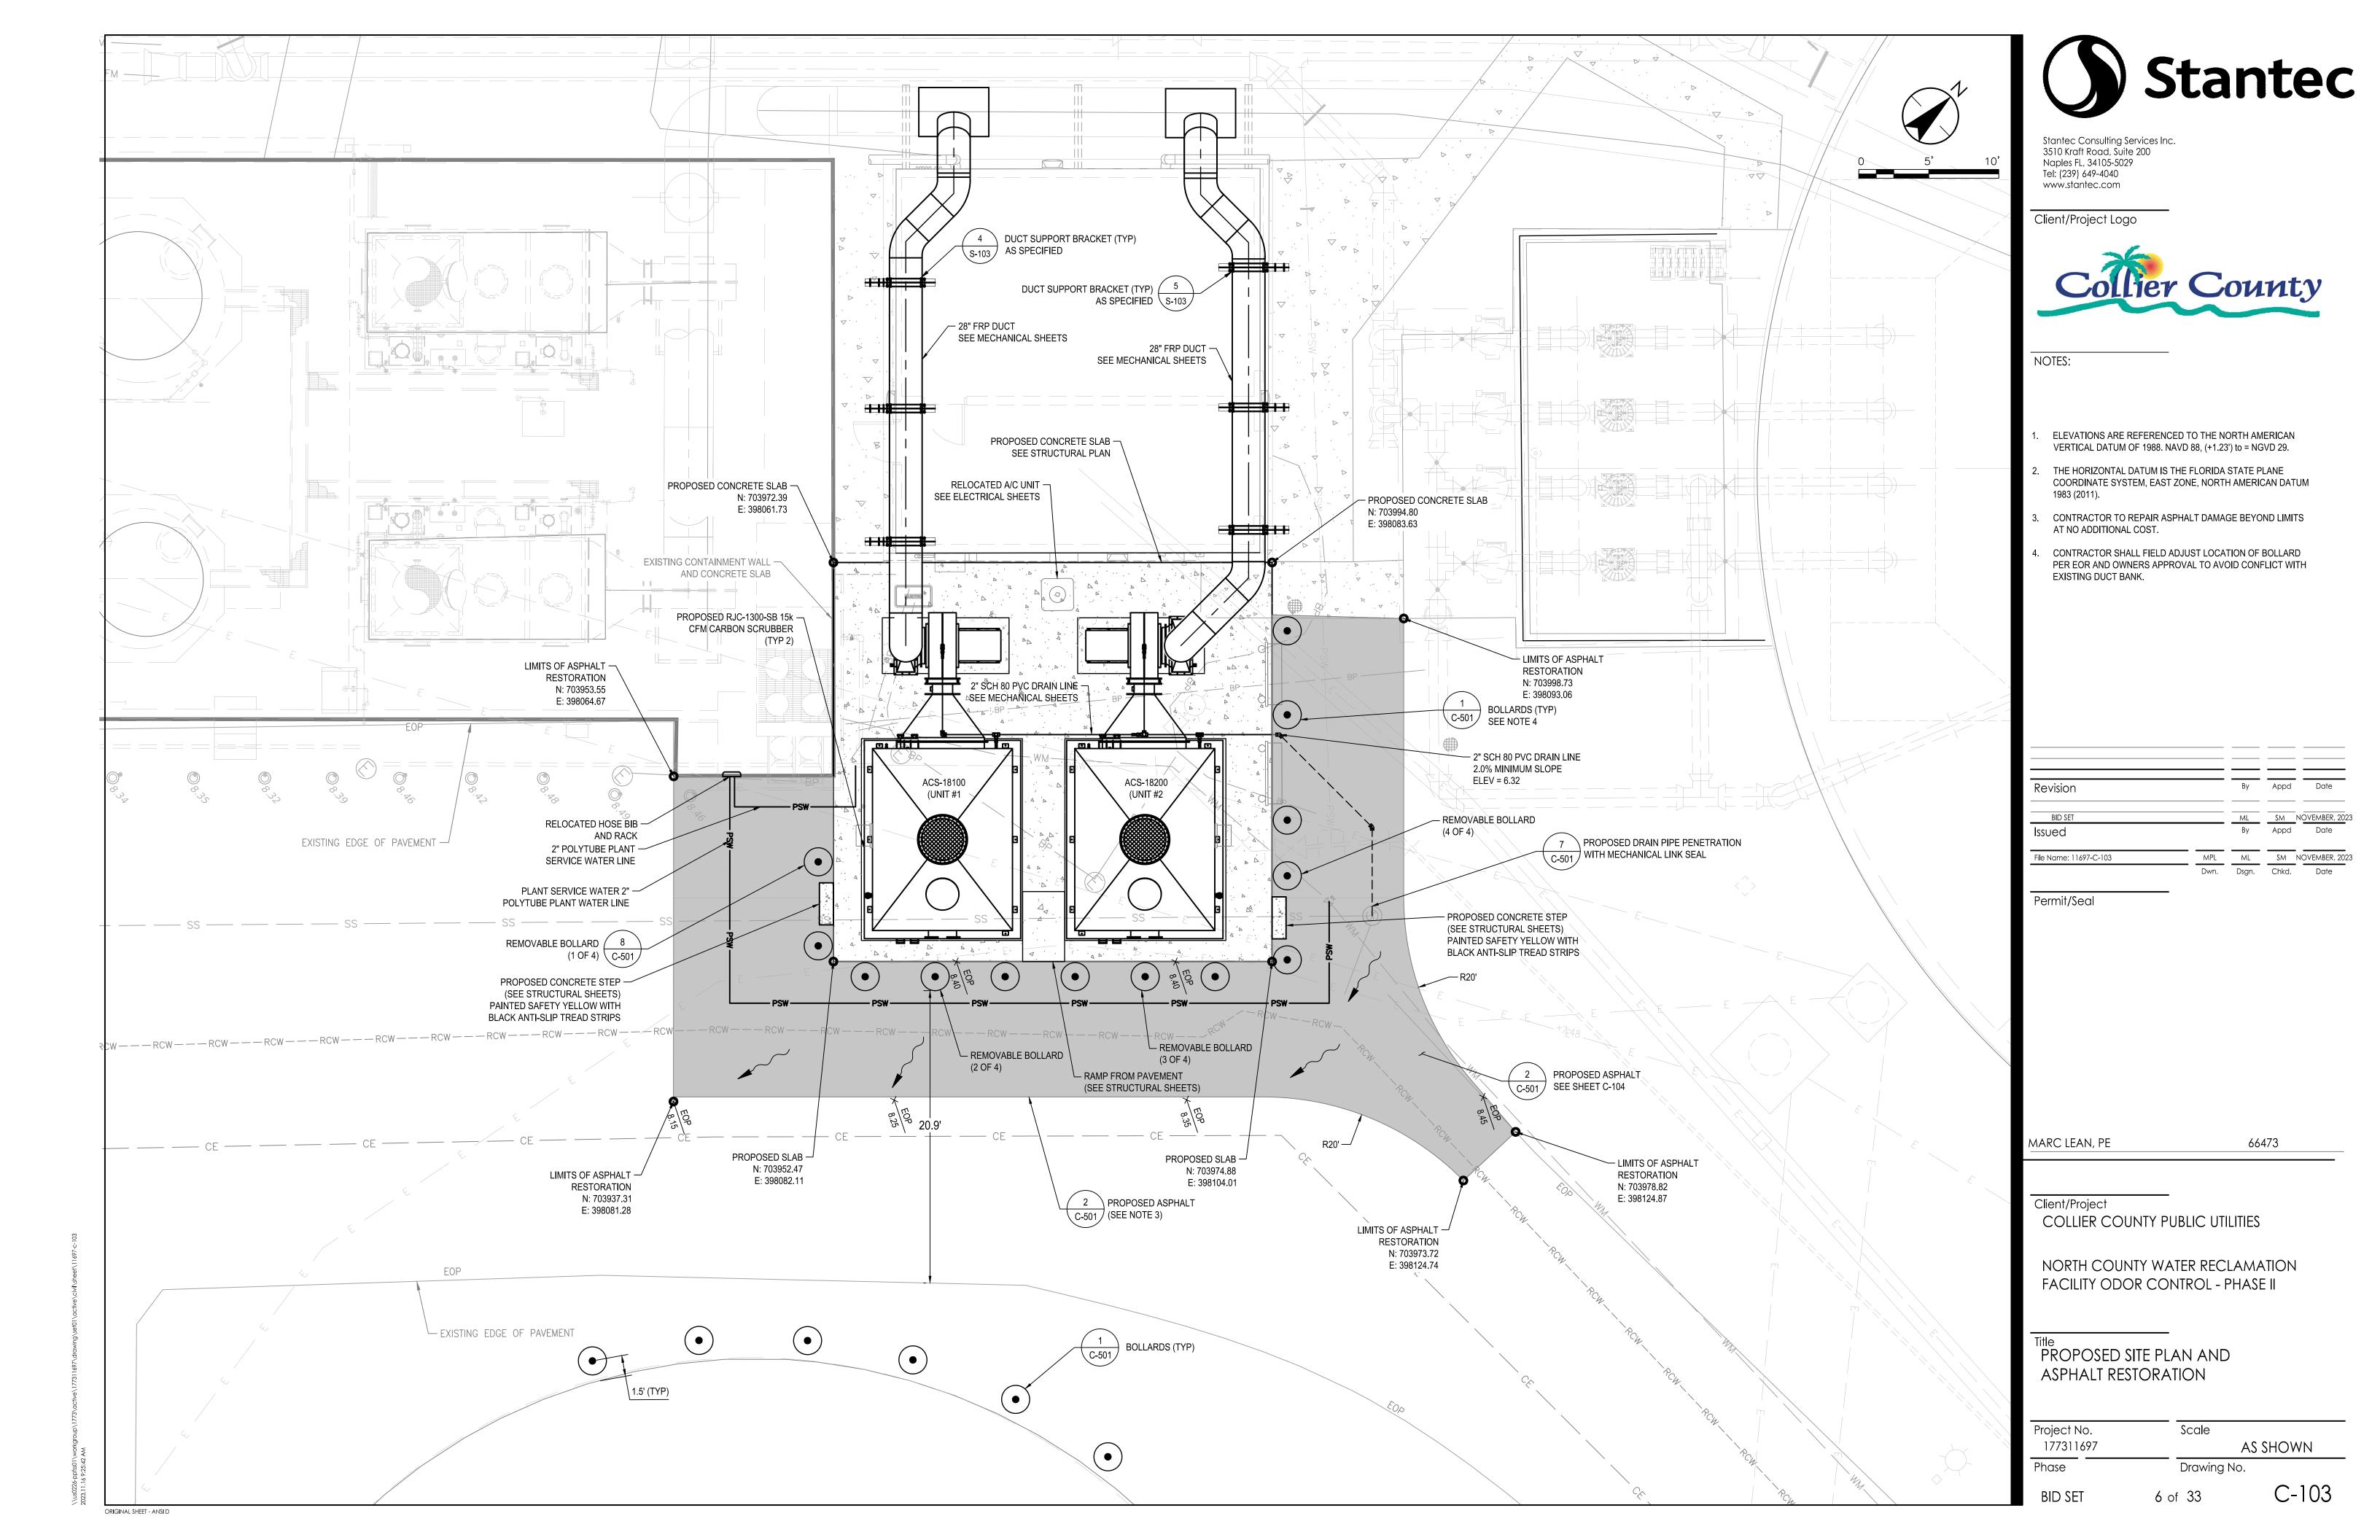

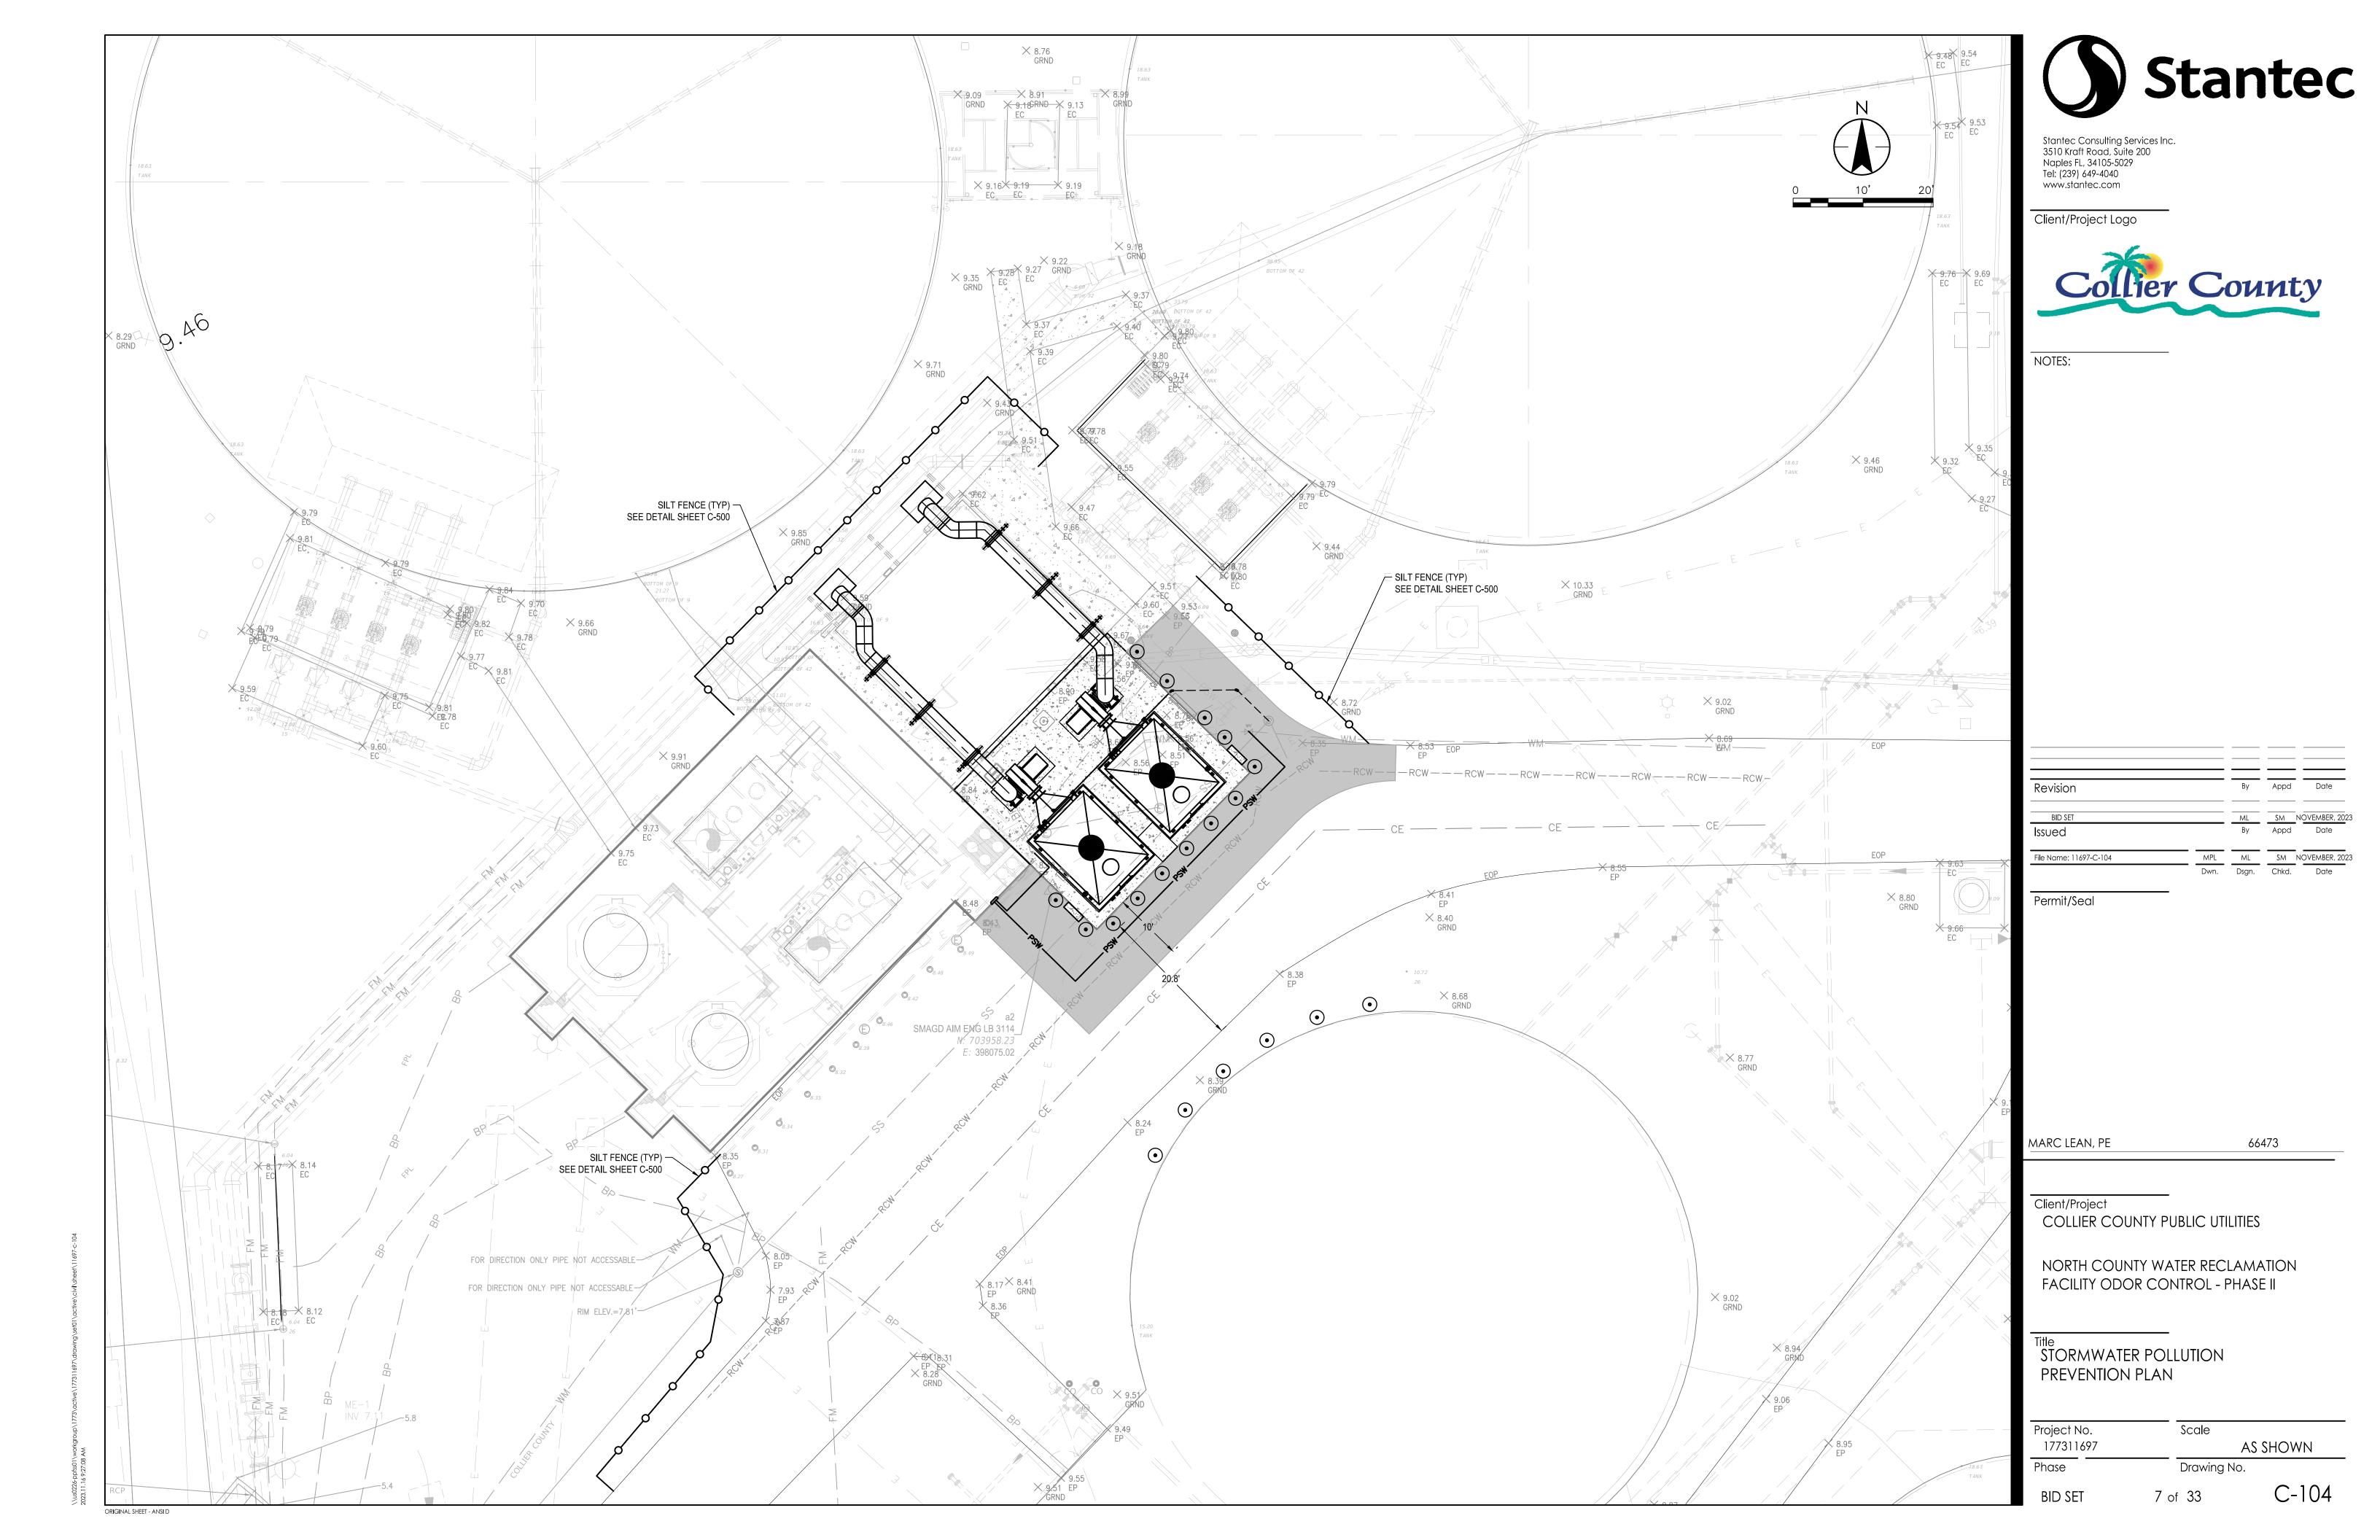


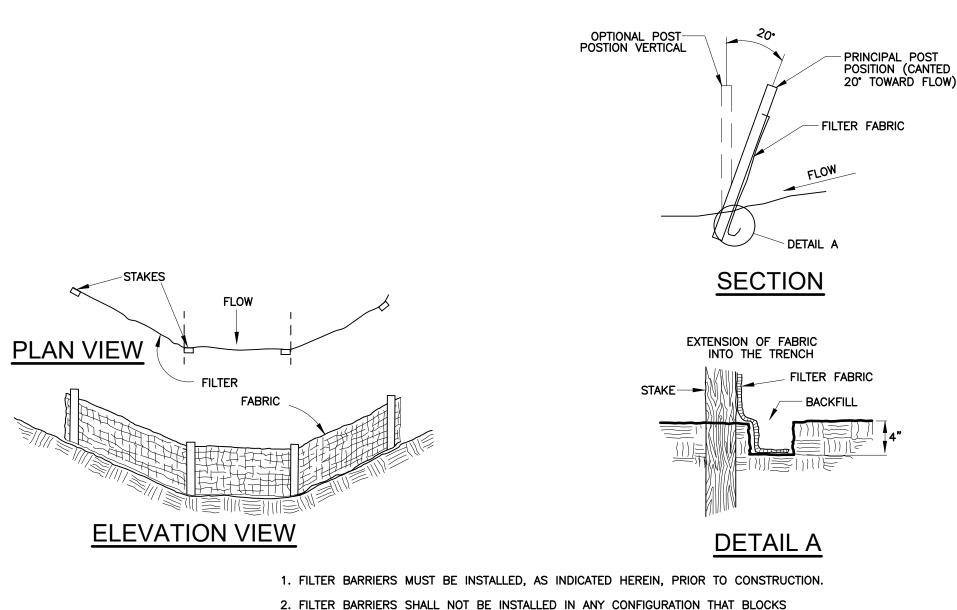


- 2. FILTER BARRIERS SHALL NOT BE INSTALLED IN ANY CONFIGURATION THAT BLOCKS THE THROAT OF ANY STORMWATER INLET.
- 3. INSPECTIONS AND REPAIRS TO BARRIERS SHALL BE MADE DAILY.
- 4. FILTER BARRIERS SHALL BE REMOVED UNTIL APPROVED BY ENGINEER.


# STAKED SILT BARRIER

( DURING CONSTRUCTION ONLY )

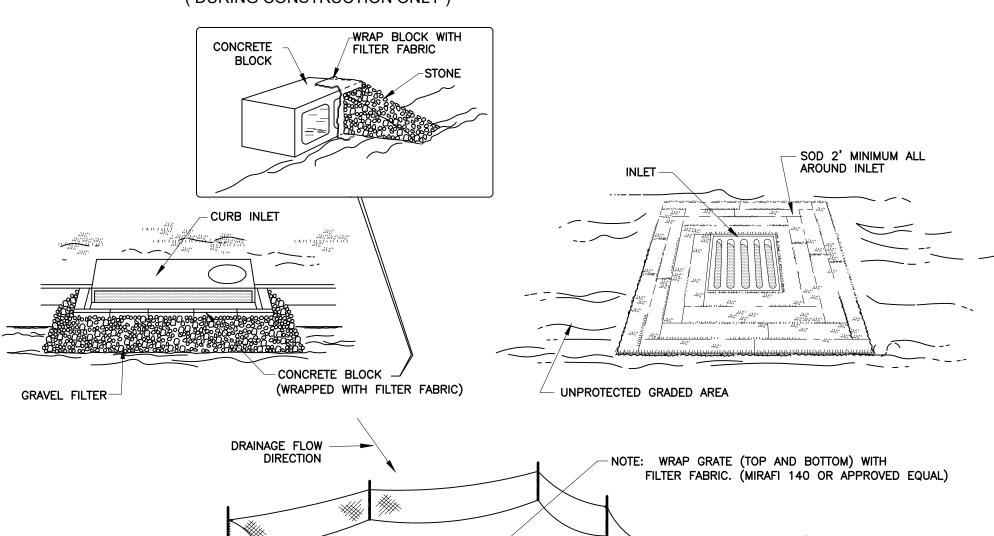

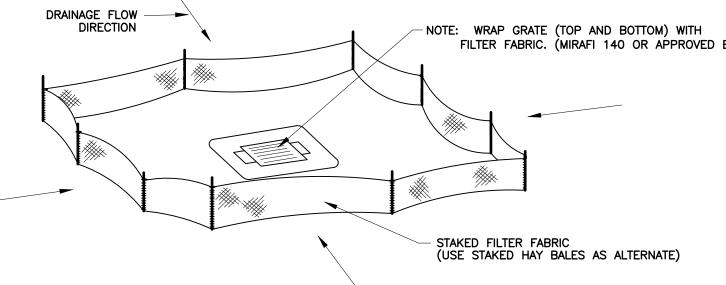


# PROTECTION OF INLETS

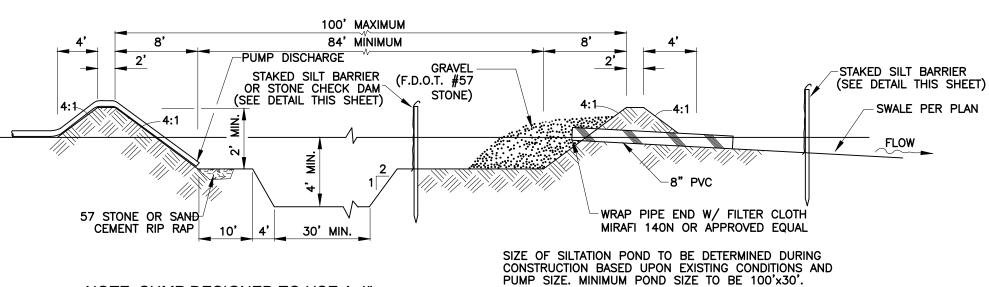

NOTE: SUMP DESIGNED TO USE A 4" DIESEL PUMP @ 200 G.P.M.


SILTATION POND DETAILS

( REQUIRED DURING DEWATERING FOR SUMP EXCAVATION ONLY )

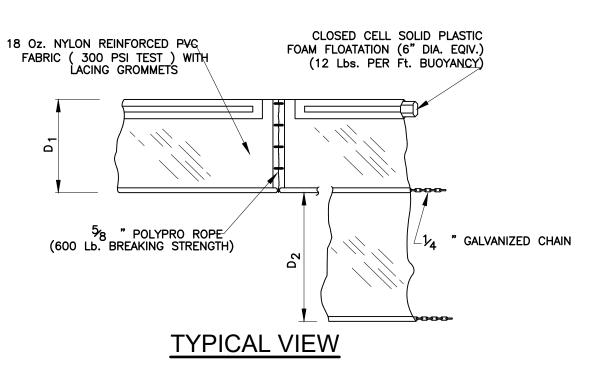


- 1. D = 5' STANDARD ( SINGLE PANEL FOR DEPTH 5' OR LESS). D = 5' STANDARD (ADDITIONAL PANEL FOR DEPTHS >5'). CURTAIN TO REACH BOTTOM UP TO DEPTHS OF 10 FEET. TWO (2) PANELS TO BE USED FOR DEPTHS GREATER THAN 10 FEET UNLESS SPECIAL DEPTH CURTAINS SPECIFICALLY CALLED FOR IN THE PLANS OR AS DETERMINED BY THE ENGINEER.
- 2. TURBIDITY BARRIERS ARE TO BE USED IN ALL PERMANENT BODIES OF WATER REGARDLESS OF WATER DEPTH WHEN ADJACENT TO CONSTRUCTION ACTIVITIES.
- 3. NUMBER AND SPACING OF ANCHORS DEPENDENT ON WATER VELOCITIES.
- 4. BARRIERS TO REMAIN IN PLACE UNTIL APPROVED FOR REMOVAL BY ENGINEER.

# FLOATING TURBIDITY BARRIER

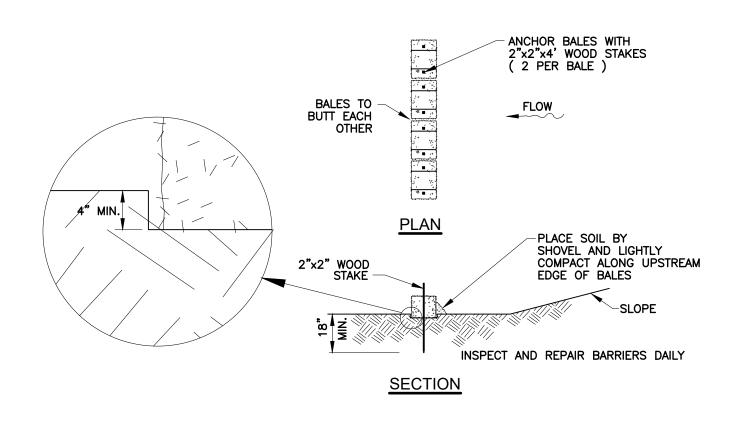

# HAY BALE SILT BARRIER

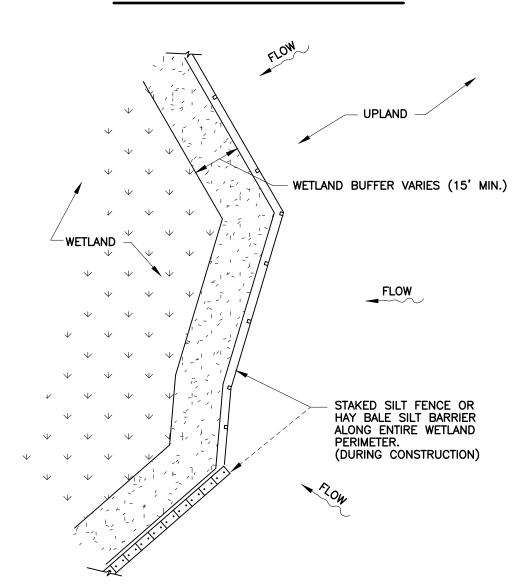

WETLAND PROTECTION

#### **EROSION CONTROL NOTES**

1. GENERAL

THE CONTRACTOR SHALL PROVIDE ALL LABOR, EQUIPMENT, TOOLS, MATERIALS AND SERVICES NEEDED TO INSTALL ALL EROSION AND SEDIMENT CONTROL MEASURES. THESE MEASURES SHALL CONFORM TO THE PLANS AND SPECIFICATIONS AND ALL APPLICABLE STATE AND LOCAL REQUIREMENTS. 2. WETLAND PROTECTION

IN AREAS OF CONSTRUCTION ADJACENT TO WETLANDS, THE FOLLOWING SHALL BE PERFORMED:

- c) NO RIM DITCHING OF THE WETLANDS SHALL BE PERFORMED. WATER LEVELS IN THE WETLANDS SHALL BE MAINTAINED ACCORDING TO LEVELS EXISTING PRIOR TO SITE DISTURBANCE.
- d) IN AREAS OF WETLANDS IN WHICH WORK IS TO BE PERFORMED, SUCH AREAS MUST BE CLEARLY STAKED AND ROPED OFF. ALONG SUCH LIMITS, A SILTATION BARRIER MUST BE CONSTRUCTED.
- e) THE CONTRACTOR SHALL BE RESPONSIBLE FOR THE MAINTENANCE OF BARRIERS. BARRIERS SHALL REMAIN IN PLACE UNTIL ALL AREAS ARE STABILIZED.
- f) THE ENGINEER SHALL BE NOTIFIED IMMEDIATELY UPON DISTURBANCE OF WETLAND AREAS.
  THE CONTRACTOR IS RESPONSIBLE FOR ANY DAMAGE TO ALL PROTECTED AREAS.
- AREAS WHERE IMPACTS WILL BE PERFORMED SHALL BE STRIPPED OF EXISTING MATERIAL AND STOCKPILED FOR USE IN THE RE-CREATION OF THE DISTURBED AREAS OR IN LITTORAL ZONES.

- TRUCTION, SCARRING, OR DEFACING OF THE NATURAL SURROUNDINGS.

  EPT WHERE CLEARING IS REQUIRED FOR PERMANENT WORK, FOR ROVED CONSTRUCTION ROADS, OR FOR EXCAVATION OPERATIONS, ALL TREES, NATIVE UBBERY AND VEGETATION SHALL BE PRESERVED AND SHALL BE PROTECTED FROM AGE WHICH MAY BE CAUSED BY THE CONTRACTOR'S CONSTRUCTION OPERATIONS

- GRADED AREAS ARE TO BE SEEDED AND/OR SODDED WITHIN THIRTY (30) DAYS FOLLOWING EARTH MOVING PROCEDURES. IF THE TIME OF YEAR IS NOT CONDUCIVE FOR PERMANENT SEEDING, A TEMPORARY MULCH AND/OR SEEDING SHOULD BE USED.
- f) THE SILT COLLECTION PONDS SHOULD BE REMOVED AND/OR REGRADED FOR PERMANENT USE, AS THE FINAL GRADING AND SEEDING OVERLAP THE AREA USED BY SAME.

#### 4. FILLS

- a) LAND TO BE CUT OR FILLED SHOULD BE CLEARED OF TREES, STUMPS, ROOTS, BRUSH, BOULDERS, SOD AND DEBRIS.
- b) FILL AREAS SHOULD BE SCARIFIED, KEYED AND DRAINED.
- c) FILL MATERIAL SHOULD BE FREE OF SOD, ROOTS, OR OTHER DECOMPOSABLE MATERIAL

# 5. CUTS

- a) DIVERSIONS SHOULD BE CONSTRUCTED AT TOP OF THE SLOPES PRIOR TO CUTTING OPERATIONS TO CONVEY WATER FROM FACE OF SLOPE.
- b) STEEPNESS OF CUTS WILL DEPEND ON SOIL TYPE AND DESIGN; HOWEVER, CUT SLOPES OF 4:1 OR FLATTER ARE DESIRABLE FOR EROSION CONTROL AND STABILITY.
- c) CUT SLOPES SHOULD BE BENCHED TO PROVIDE ACCESS FOR SEEDING AND MULCHING EQUIPMENT.
- d) CUT SLOPES SHOULD BE SEEDED AND/OR MULCHED IMMEDIATELY AFTER REMOVAL OF EARTH.
- 6. TEMPORARY SEDIMENT BASIN AND PERMANENT STORMWATER BASINS

# a) SITE PREPARATION

- b) CUT-OFF TRENCH
- c) EMBANKMENT
- OF ROOTS, WOODY VEGETATIONS, OVER—SIZED STONES, ROCKS OR OTHER BLE MATERIAL. AREAS ON WHICH FILL IS TO BE PLACED SHALL BE SCARIFIED PRIOR INTO FILL. FILL MATERIAL SHALL BE PLACED IN SIX TO EIGHT INCHES THICK LAYERS OVER THE ENTIRE LENGTH OF THE FILL. COMPACTION SHALL BE OBTAINED HAULING EQUIPMENT OVER THE FILL SO THAT THE ENTIRE SURFACE OF EACH LAYER IS TRAVERSED BY AT LEAST ONE WHEEL OF TREAD TRUCK OF THE EQUIPMENT OR BE A COMPACTOR. THE EMBANKMENT SHALL BE CONSTRUCTED TO AN ELEVATION OF THAN THE DESIGN HEIGHT TO ALLOW FOR SETTLEMENT IF COMPACTION IS OBTAINED IN THE OVERBUILD MAY TO NOT ITSS THAN 5%.
- d) PIPE SPILLWAYS
- e) EROSION POLLUTION CONTROL

CONSTRUCTION OPERATIONS SHALL BE CARRIED OUT IN SUCH A MANNER THAT EROSION AND WATER POLLUTION WILL BE MINIMIZED. STATE AND LOCAL LAWS CONCERNING POLLUTION ABATEMENT SHALL BE COMPLIED WITH.

- 7. MAINTENANCE
- a) REPAIR ALL DAMAGES CAUSED BY SOIL EROSION OR CONSTRUCTION EQUIPMENT AT OR BEFORE THE END OF EACH WORK DAY.



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Appd Revision Issued File Name: 11697-C-500

Permit/Seal

MARC LEAN, PE

Client/Project

COLLIER COUNTY PUBLIC UTILITIES


NORTH COUNTY WATER RECLAMATION FACILITY ODOR CONTROL - PHASE II


BEST MANAGEMENT PRACTICES

Project No. Scale 177311697 Phase Drawing No. **BID SET** 8 of 33

C-500

66473

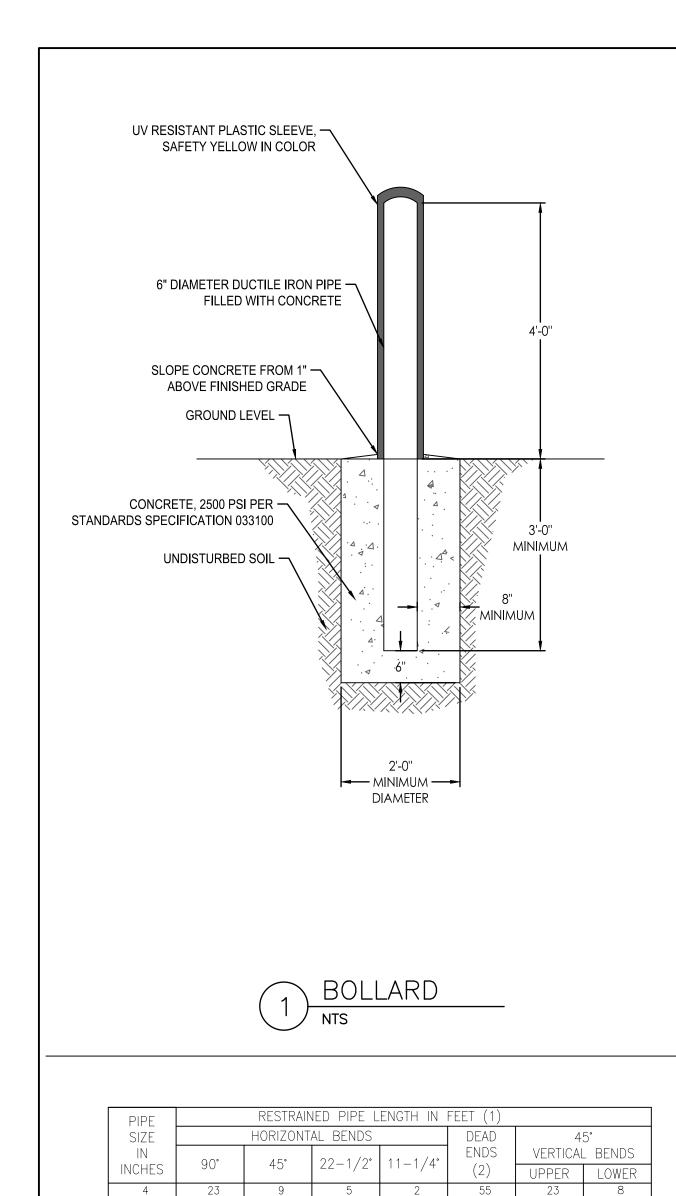

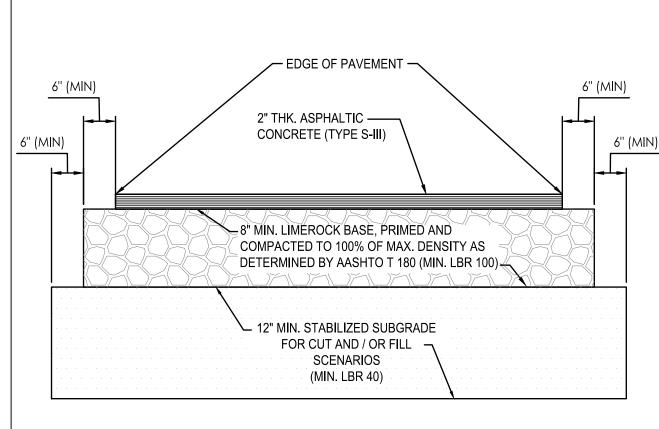

**ROADWAY COMPACTION NOTES:** 

BASE SHALL BE ADHERED TO.

1. THE STABILIZED SUBGRADE SHALL BE COMPACTED TO 100% OF THE

2. THE LIMEROCK BASE SHALL BE COMPACTED IN 6" LIFTS TO 100% OF

3. ASPHALTIC CONCRETE PAVEMENT (TYPE S-III) SHALL BE PLACED IN TWO 1" LIFTS, ACCORDING TO AASHTO ASPHALT MANUAL.

THE ENGINEERS TECHNICAL SPECIFICATIONS.


THE MAXIMUM DENSITY, IN ACCORDANCE WITH AASHTO T-180 AND

TYPICAL ASPHALT PAVEMENT

MAXIMUM DENSITY, IN ACCORDANCE WITH AASHTO T-180 AND THE ENGINEERS TECHNICAL SPECIFICATIONS. 5-1/2" LIMEROCK BASE MATERIAL MAY BE SUBSTITUTED AS AN ALTERNATE DESIGN TO THE 12" STABILIZED SUBGRADE. ALL SPECIFICATIONS FOR LIMEROCK

NOT INCLUDED IN SET

NOT INCLUDED IN SET

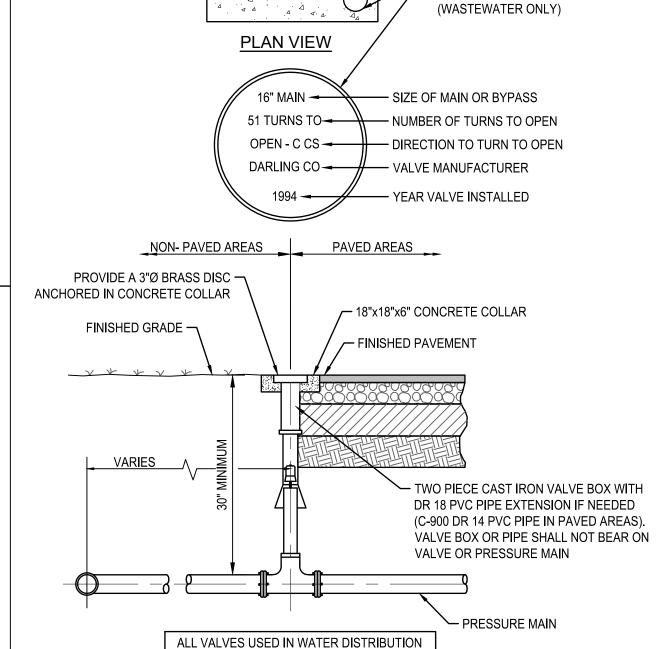

SYSTEMS SHALL BE OF THE RESILIENT SEAT TYPE IN ACCORDANCE WITH AWWA C-515

FIXED BOLLARD

CUSTOM SUPPLIED

- EMBEDMENT SLEEVE

SPECIFY LETTERING AS "IRR",

"SEWER", OR "WATER", DEPENDING

– PROVIDE A 3"Ø BRASS DISC

PLAN VIEW OF CLOSED LID

EXISTING GRADE

ANCHORED IN CONCRETE COLLAR

18"x18"x6" CONCRETE COLLAR -



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TYPICAL VALVE SETTING Revision Appd Date Issued File Name: 11697-C-501

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66473

C-501

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NORTH COUNTY WATER RECLAMATION FACILITY ODOR CONTROL - PHASE II

CIVIL DETAILS

Project No. Scale AS SHOWN 177311697 Phase Drawing No.

9 of 33 **BID SET** 

24''Ø

PROPOSED CONCRETE STEP (SEE STRUCTURAL SHEETS) PAINTED SAFETY YELLOW WITH

8 - #6 V —

5 #4 STIRRUPS —

REFER SHEET S-102 FOR SUPPLEMENTAL VIEW


LOCK, OR APPROVED EQUAL.

CAL PIPE SECURITY BOLLARDS IBP06040 SCHEDULE 40 ASTM A-53

CARBON STEEL POWDER COATED SAFETY YELLOW, WITH EXTERNAL PAD


BLACK ANTI-SLIP TREAD STRIPS

ODOR CONTROL SLAB

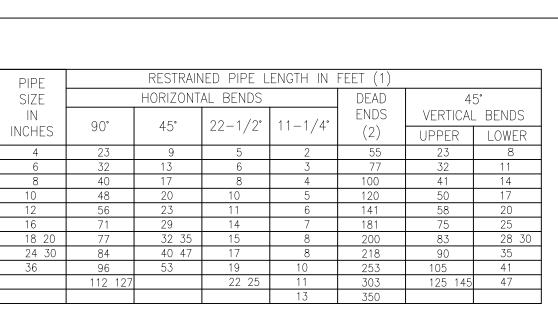

PIPE SIZE	RESTRAINED PIPE LENGTH IN FEET (1)			
IN INCHES	TEE (3)	REDUCER (4)		
6 x 4	0	40		
6 x 6	34			
8 x 4	0	72		
8 x 8	55			
10 x 6 10	3	74		
x 10 12 x	75			
4	0	122		
12 x 8	31	75		
12 x 12	95			
16 x 6	0	153		
16 x 10	44	107		
16 x 16	134			
18 x 8	0	157		
18 x 12	68	108		
18 x 18	152			
20 x 10	20	161		
20 x 16	120	77		
20 x 20	170			
24 x 12	37	187		
24 x 18	132	109		
24 x 24	204			
30 x 16	78	213		
30 x 20	138	165		
30 x 30	252	255		
36 x 18	84	259		
36 x 24	170	191		


- 1. RESTRAIN ALL PIPE JOINTS WITHIN THE DISTANCE SHOWN ON THE TABLES MEASURED FROM THE POINT OF CONNECTION.
- 2. ISOLATION VALVES SHALL BE TREATED AS DEAD ENDS. WITH RESTRAINT ON BOTH SIDES OF THE VALVE. 3. RESTRAINT IS FOR BRANCH OF TEE. IF BRANCH SIZE IS
- NOT ON TABLE, USE NEXT LARGEST BRANCH. 4. RESTRAINT IS FOR LARGE DIAMETER SIDE OF REDUCER. IF REDUCER SIZE IS NOT ON TABLE, USE NEXT SMALLER
- 5. THIS SCHEDULE IS TO BE USED FOR DUCTILE IRON AND PVC PIPE.

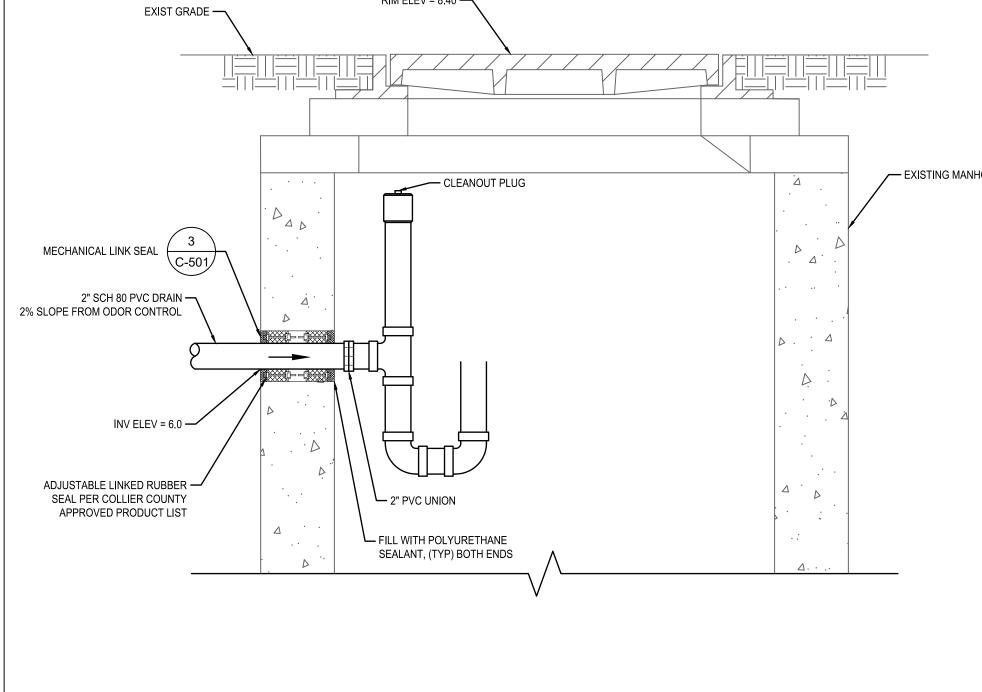



P-TRAP CONNECTION TO EXISTING MANHOLE


PIPE RESTRAINT SCHEDULE

RIM ELEV = 8.40 — EXISTING MANHOLE

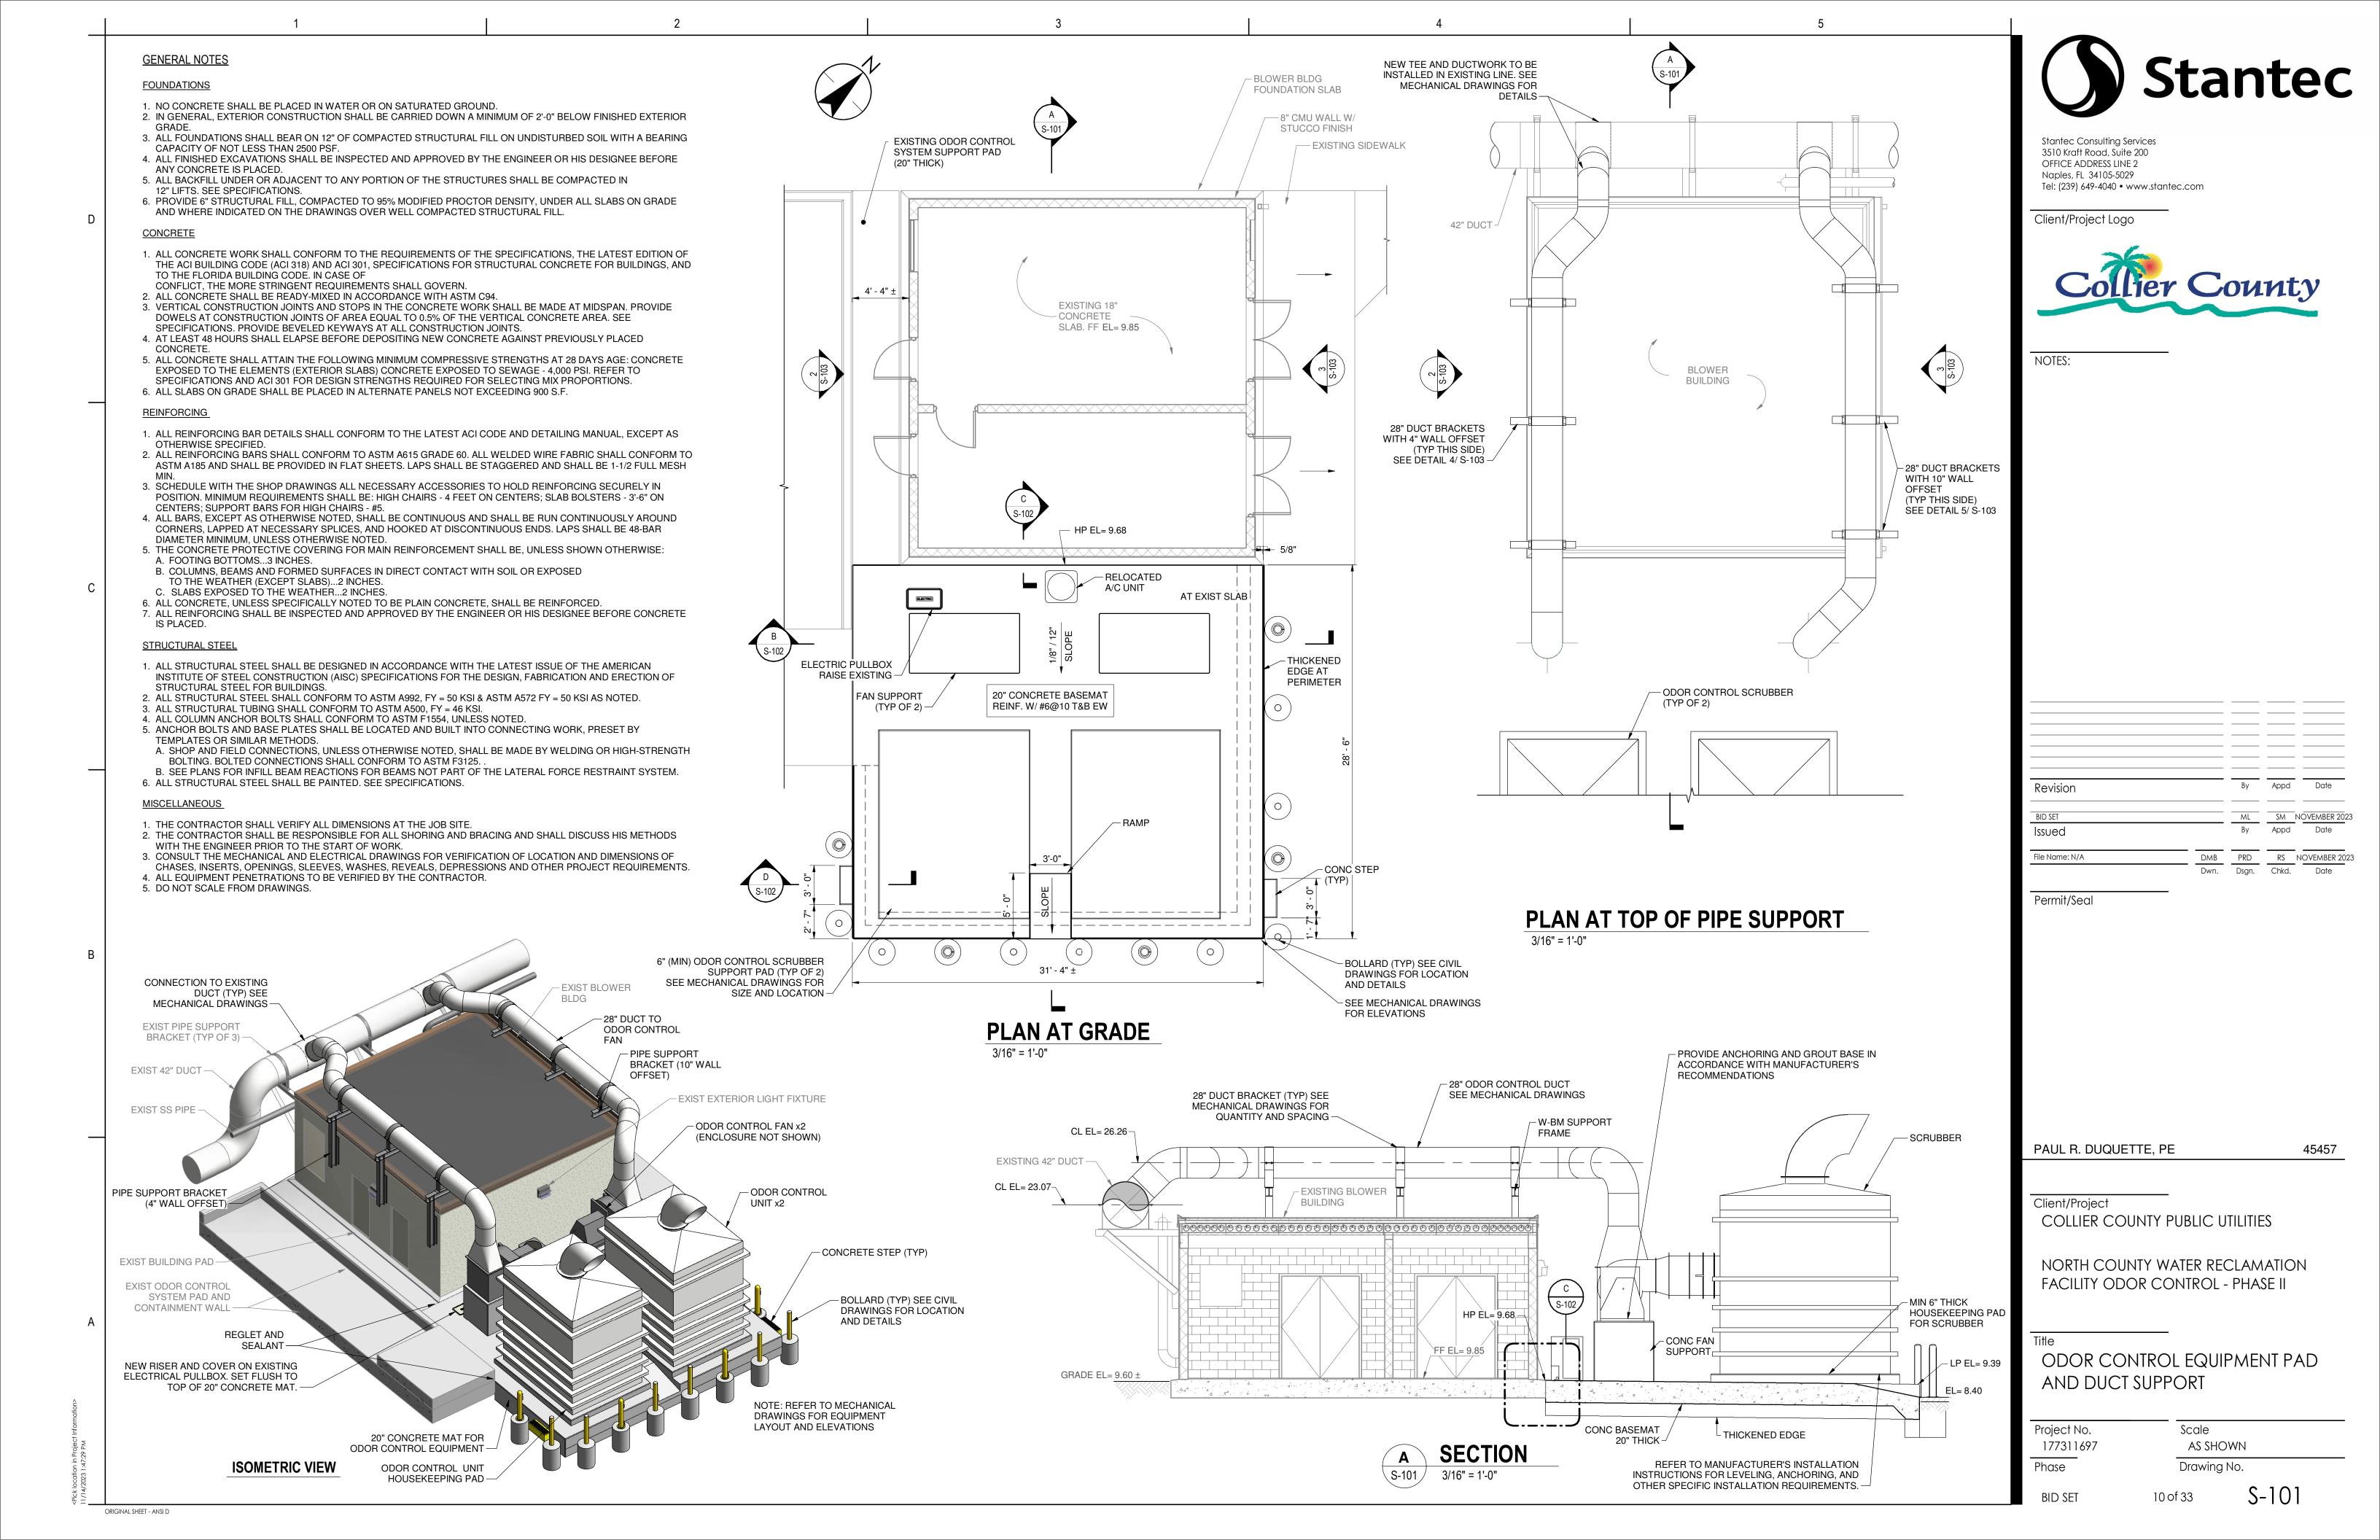

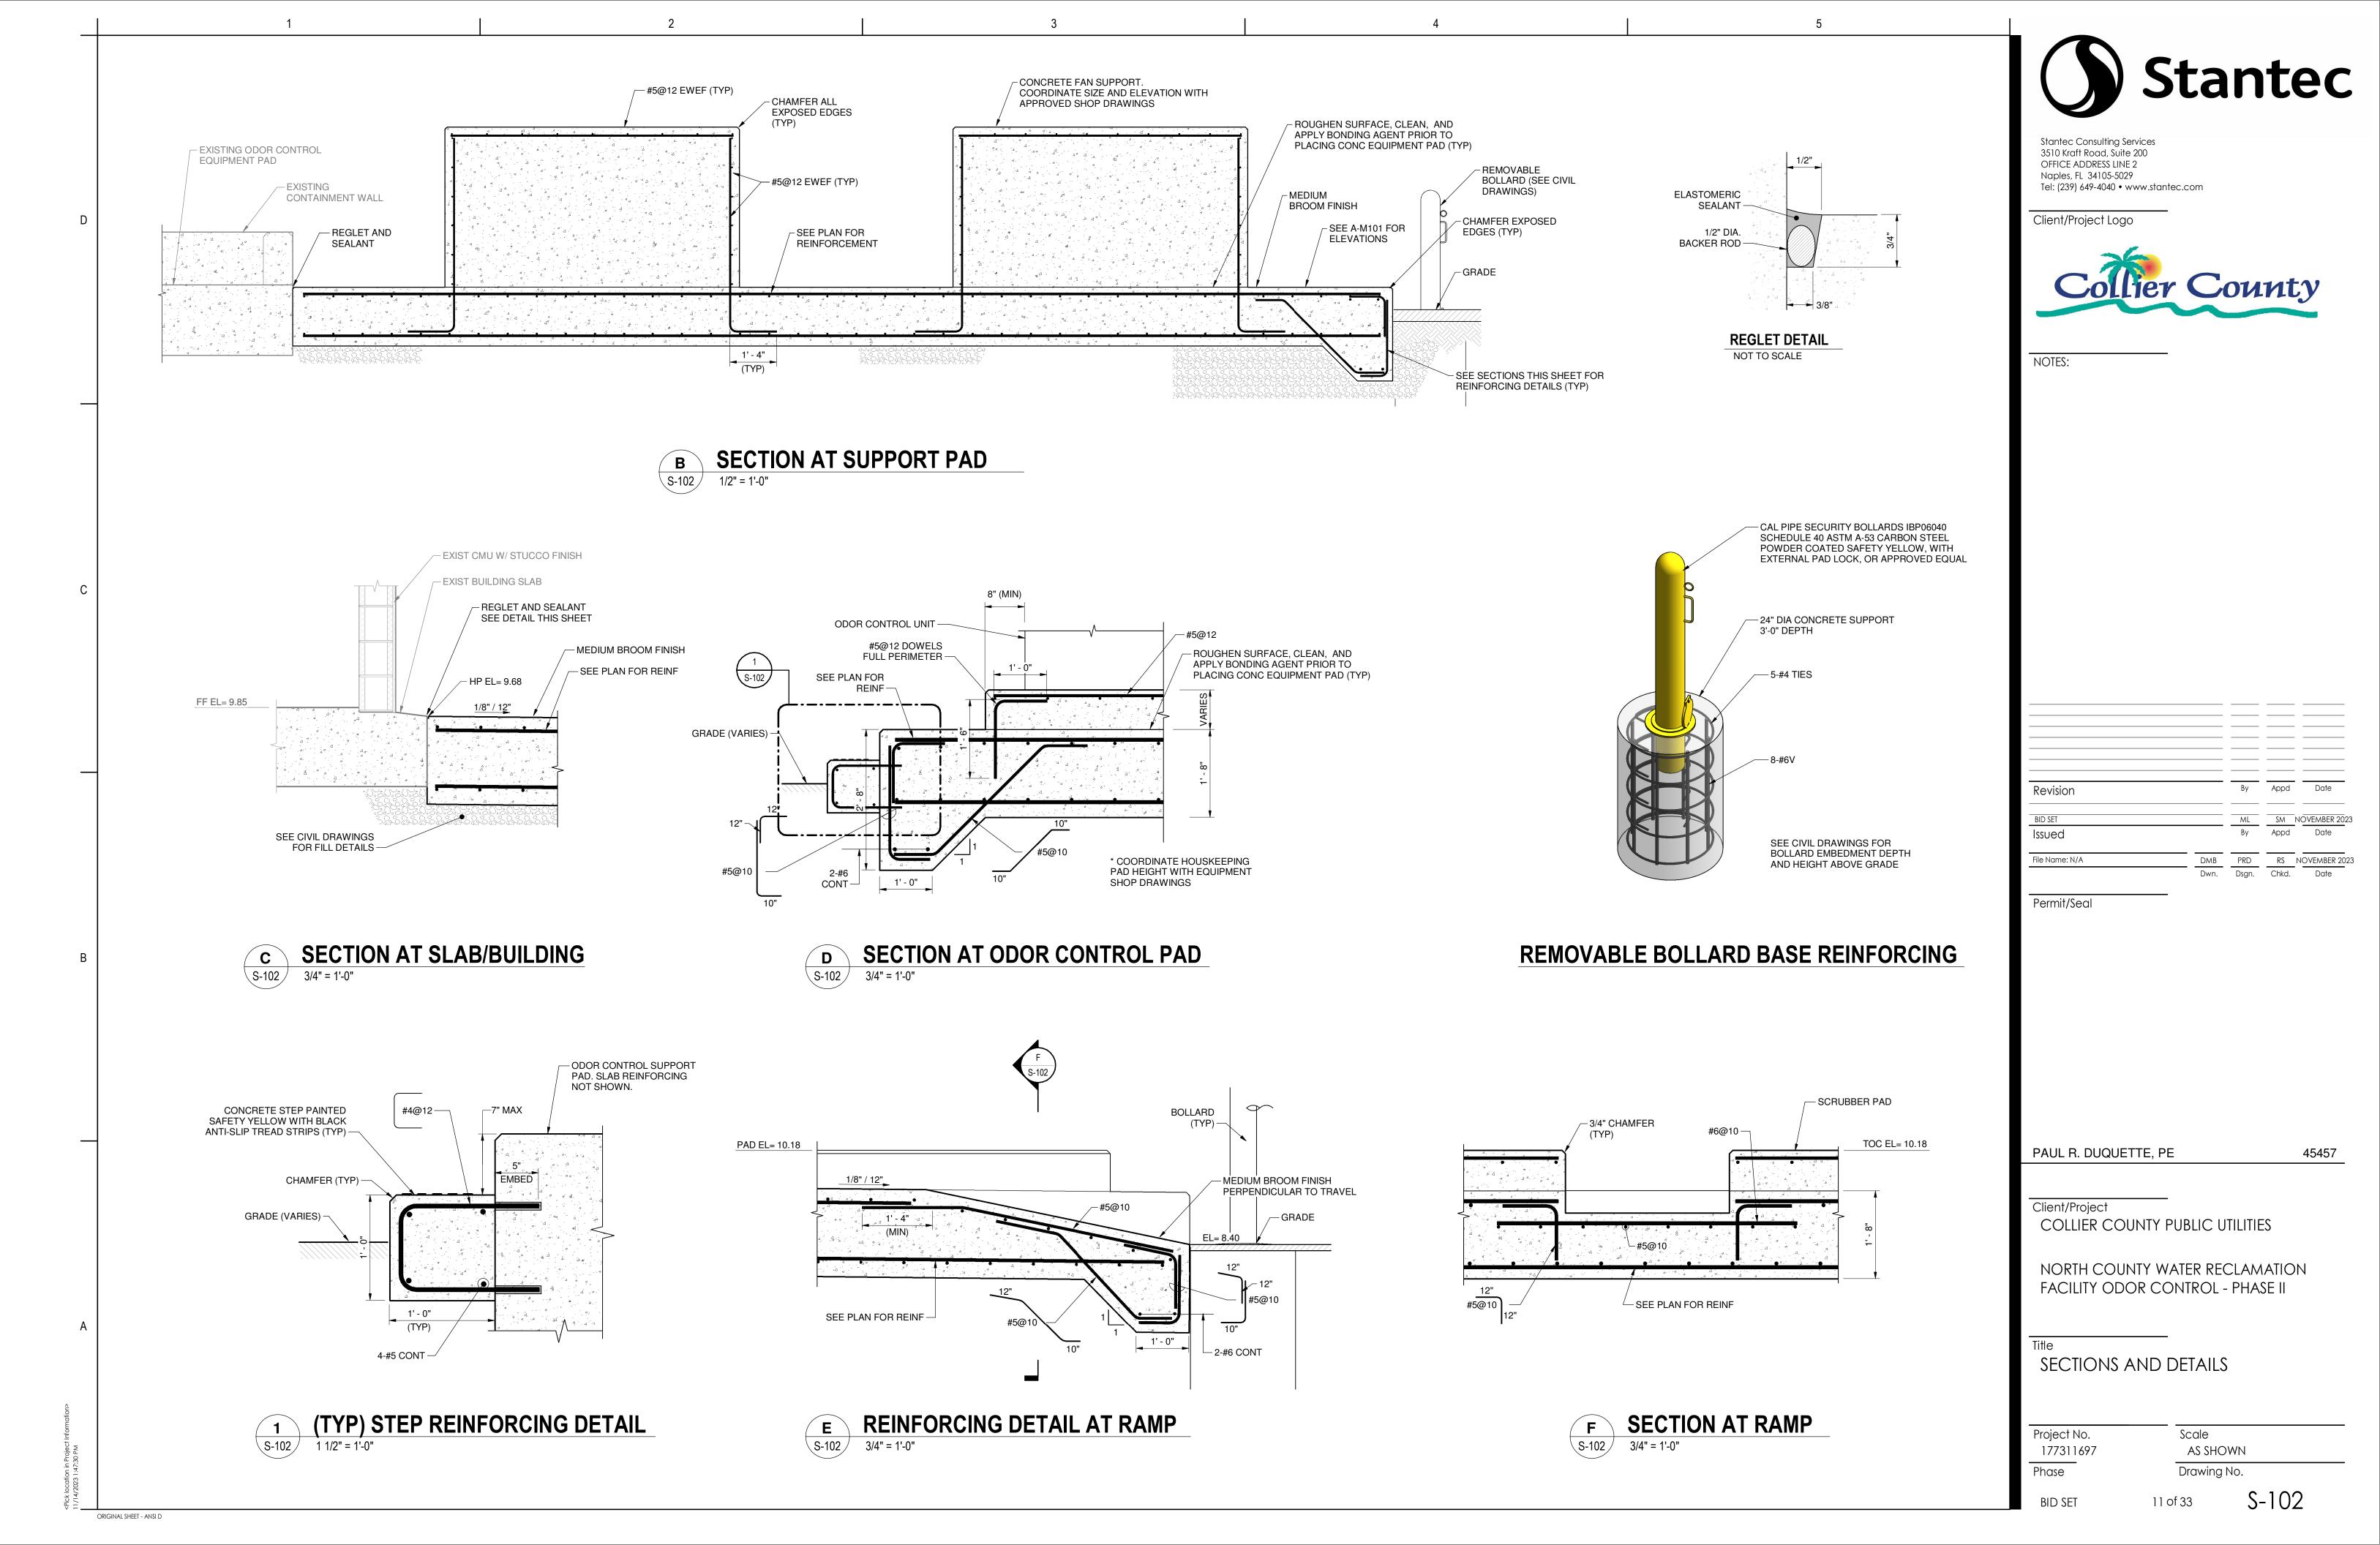

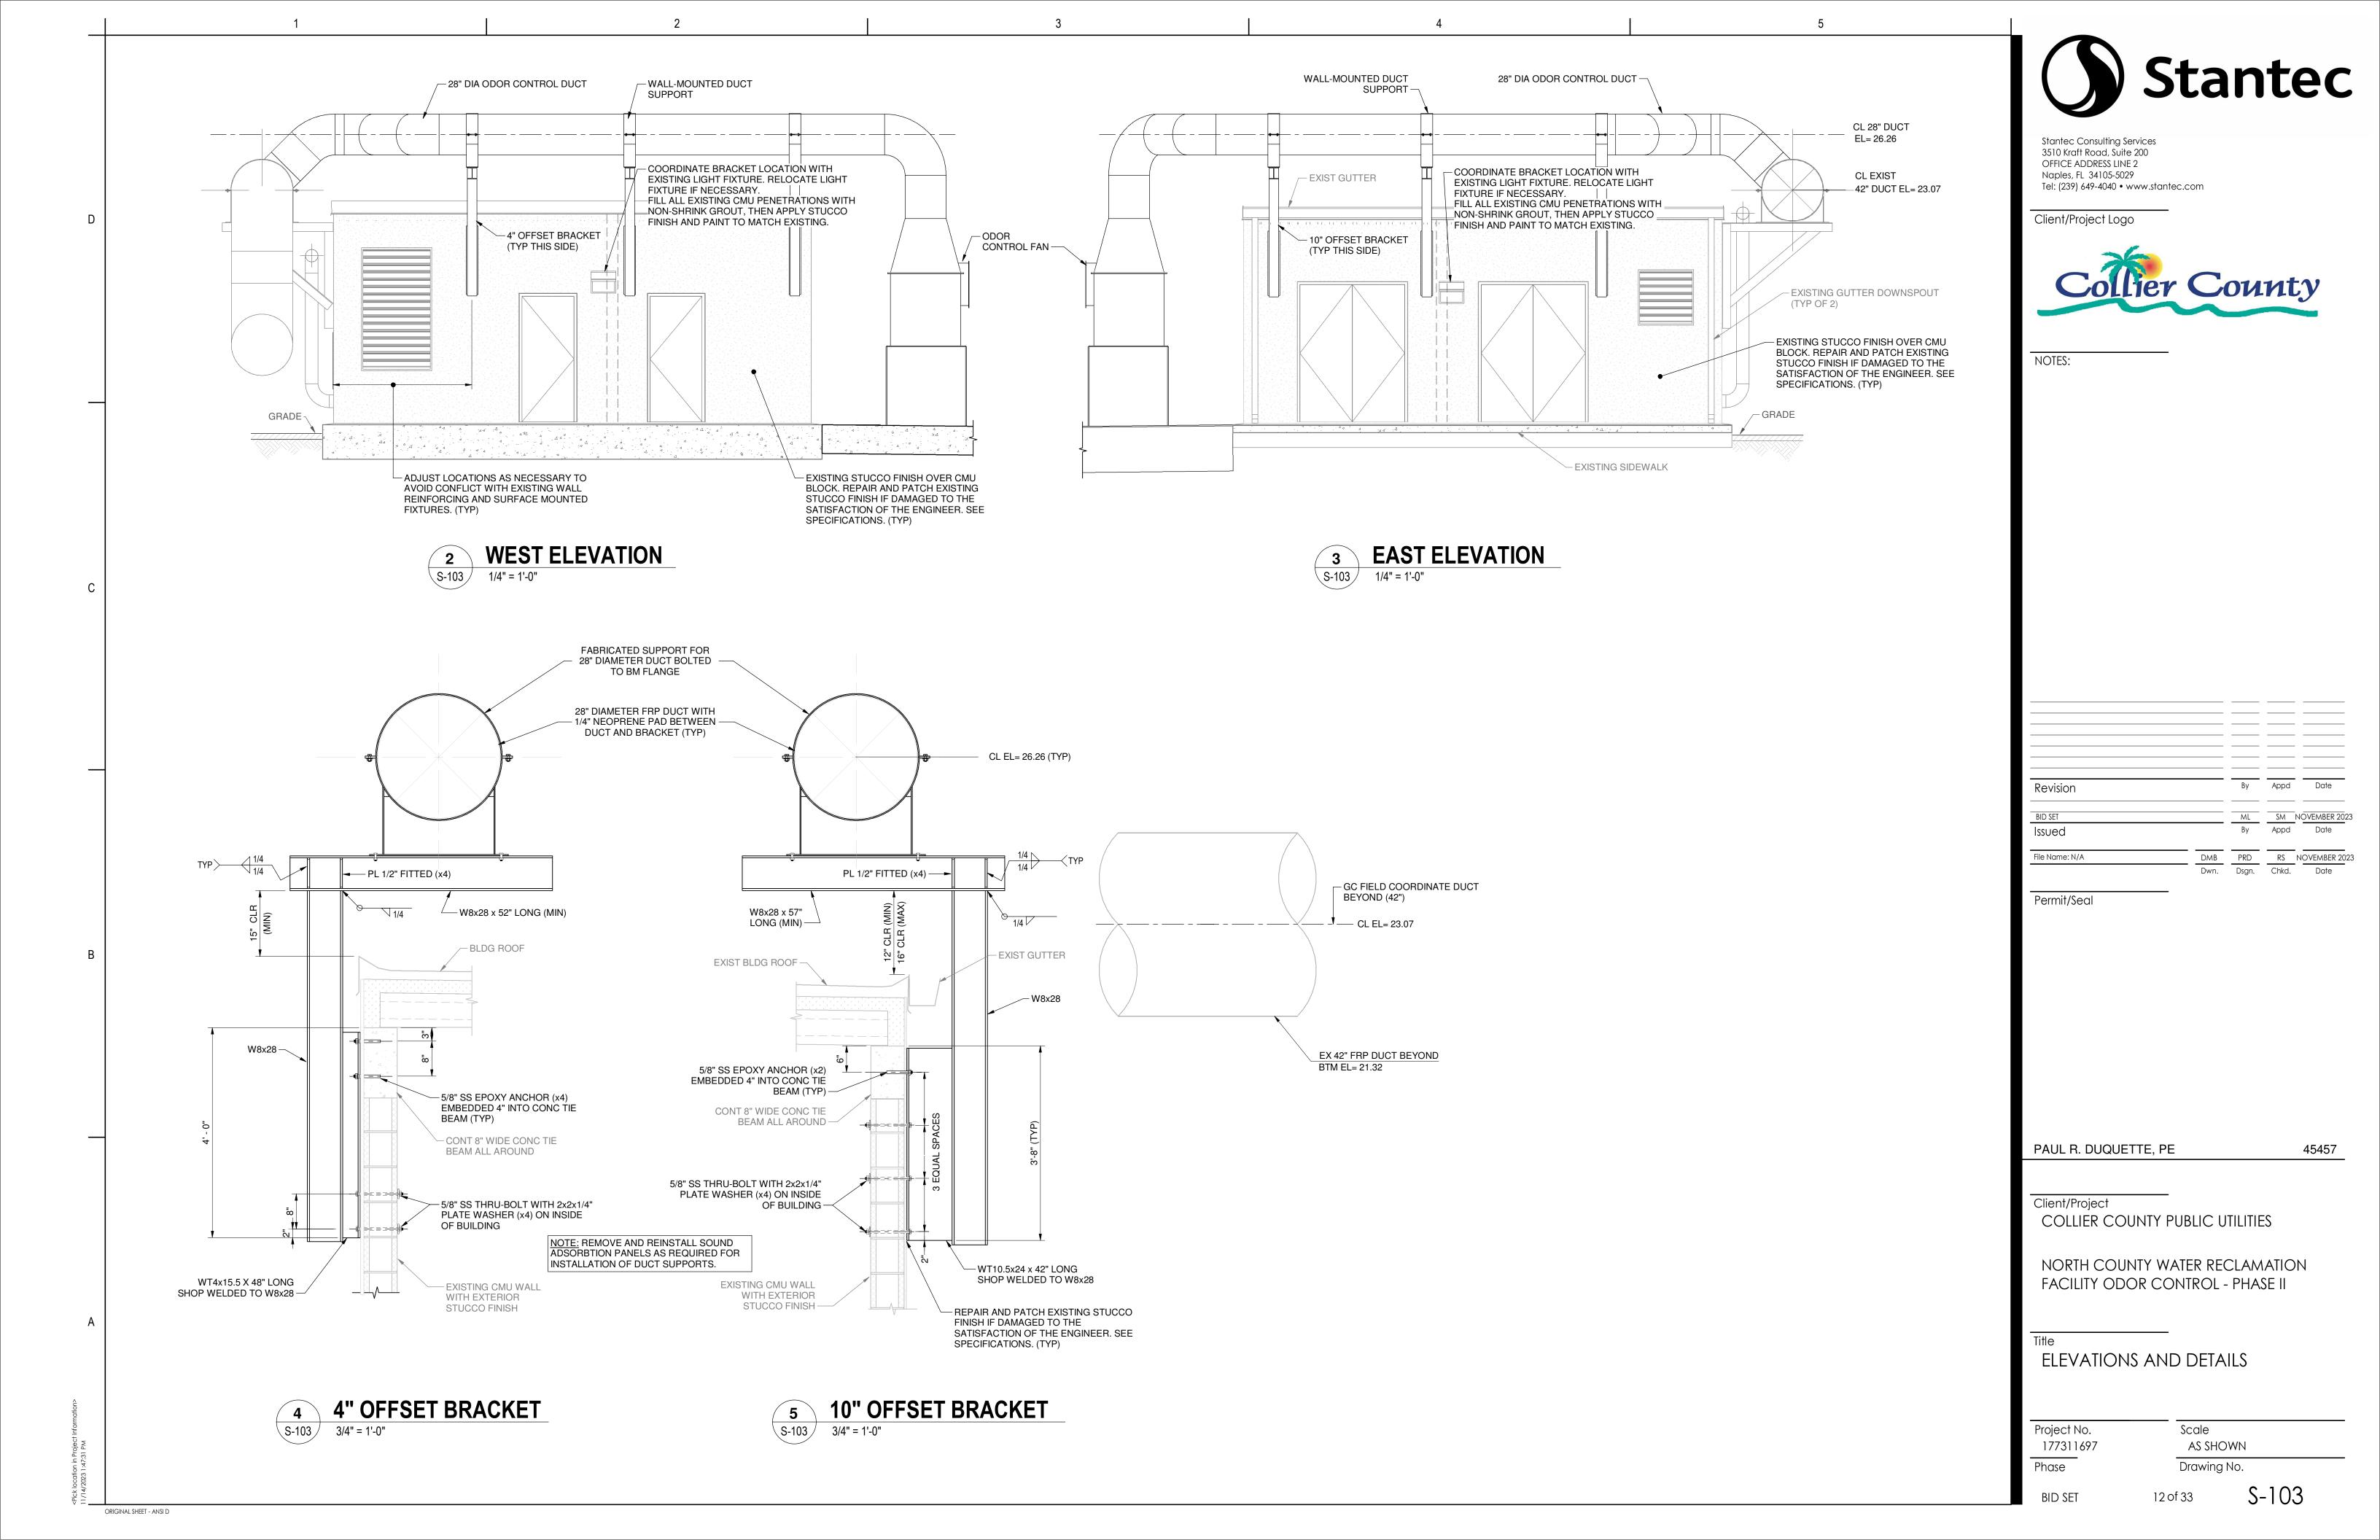


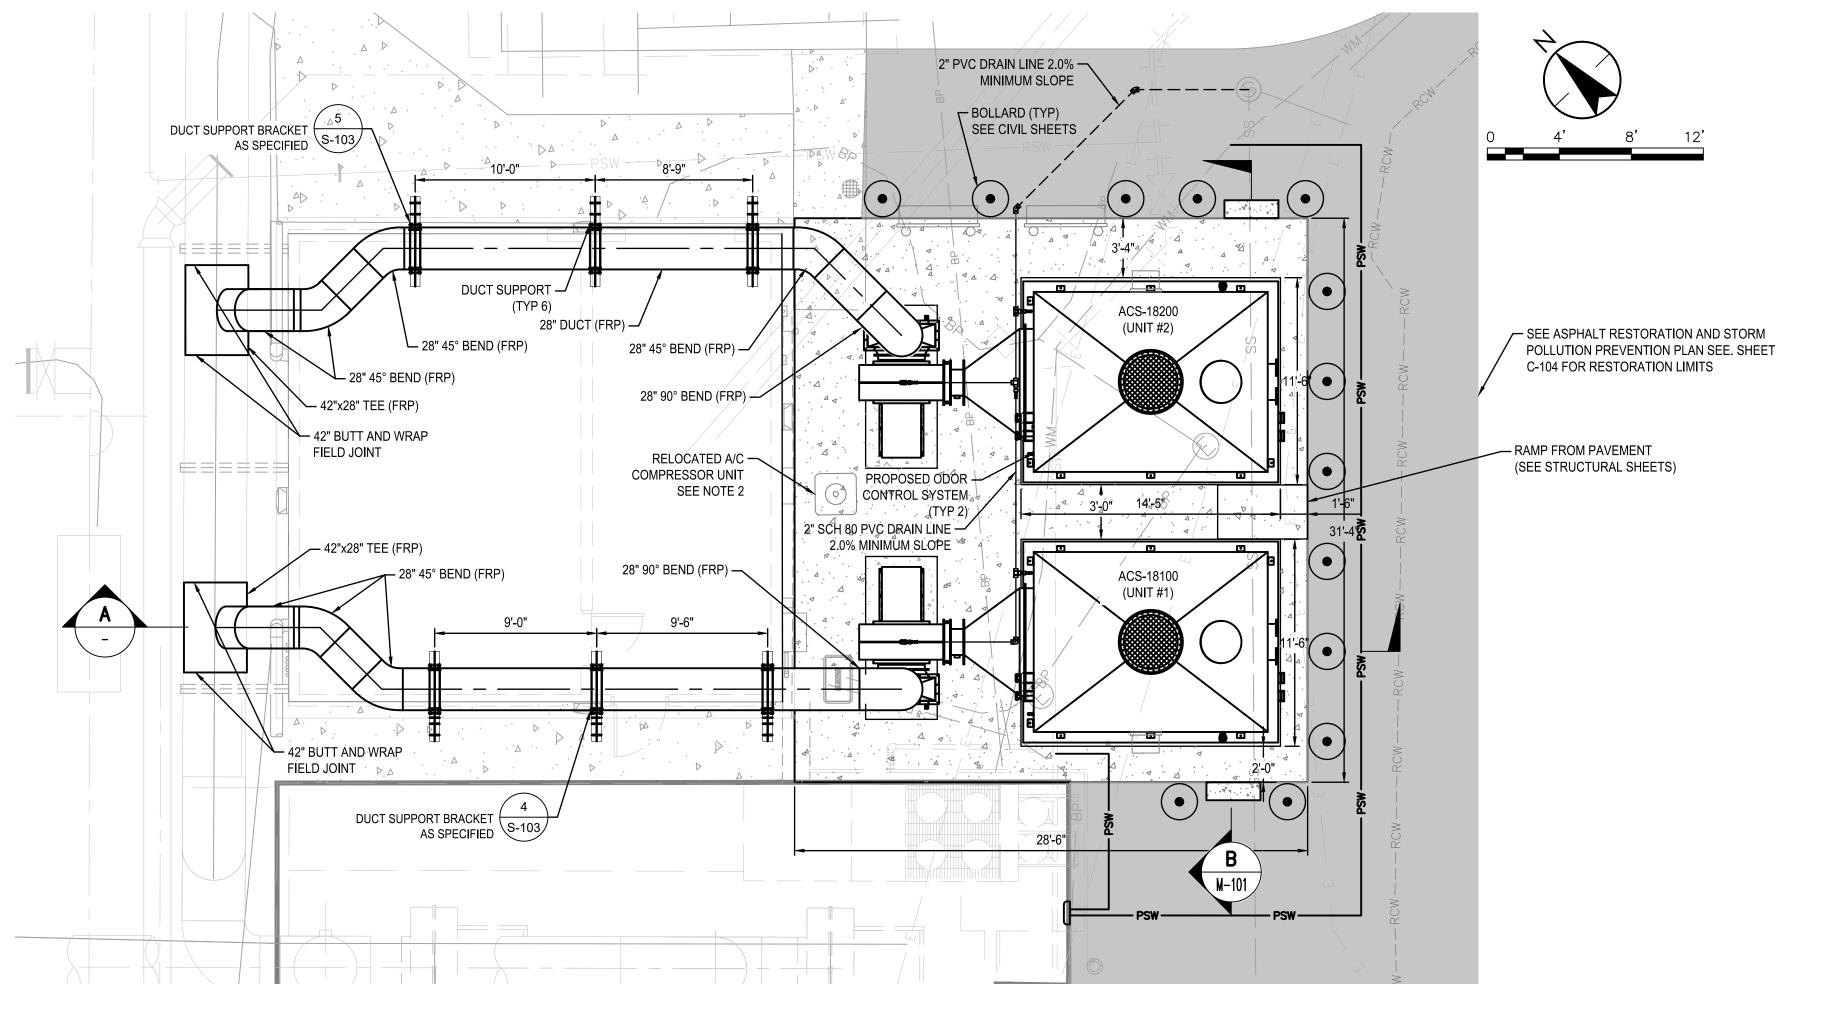

VENDOR	R PROVIDED ODOR CONTROL EQUIPMENT LIST
ITEM	DESCRIPTION
1	EXHAUST FAN
2	EXHAUST FAN OUTLET TRANSITION
3	ISOLATION DAMPER WITH CHAIN-WHEEL GEAR OPERATOR
4	36" ID EXHAUST STACK (WITH BIRD SCREEN) (TYP 1)
5	24" ID ACCESS MANWAY (TYP 2)
6	CARBON BED DIFFERENTIAL PRESSURE GAUGE (TYP 2)
7	1" CARBON SAMPLE VALVES (TYP 6)
8	2" VESSEL DRAIN
9	CARBON BED GROUNDING ROD (TYP 2)
10	ID TAB
11	CAUTION TAG
12	LOGO
13	ANCHOR LUGS (TYP 8)
14	LIFTING LUGS (TYP 8)
15	INLET AIR SAMPLE PORT
16	OUTLET AIR SAMPLE PORT (TYP 2)
17	NFPA LABEL
18	12" ID ACCESS
19	FAN OUTLET FLEXIBLE CONNECTOR
20	28" ISOLATION DAMPENER WITH CHAIN-WHEEL GEAR OPERATOR
21	VESSEL



SCALE: 3/16" = 1'-0"

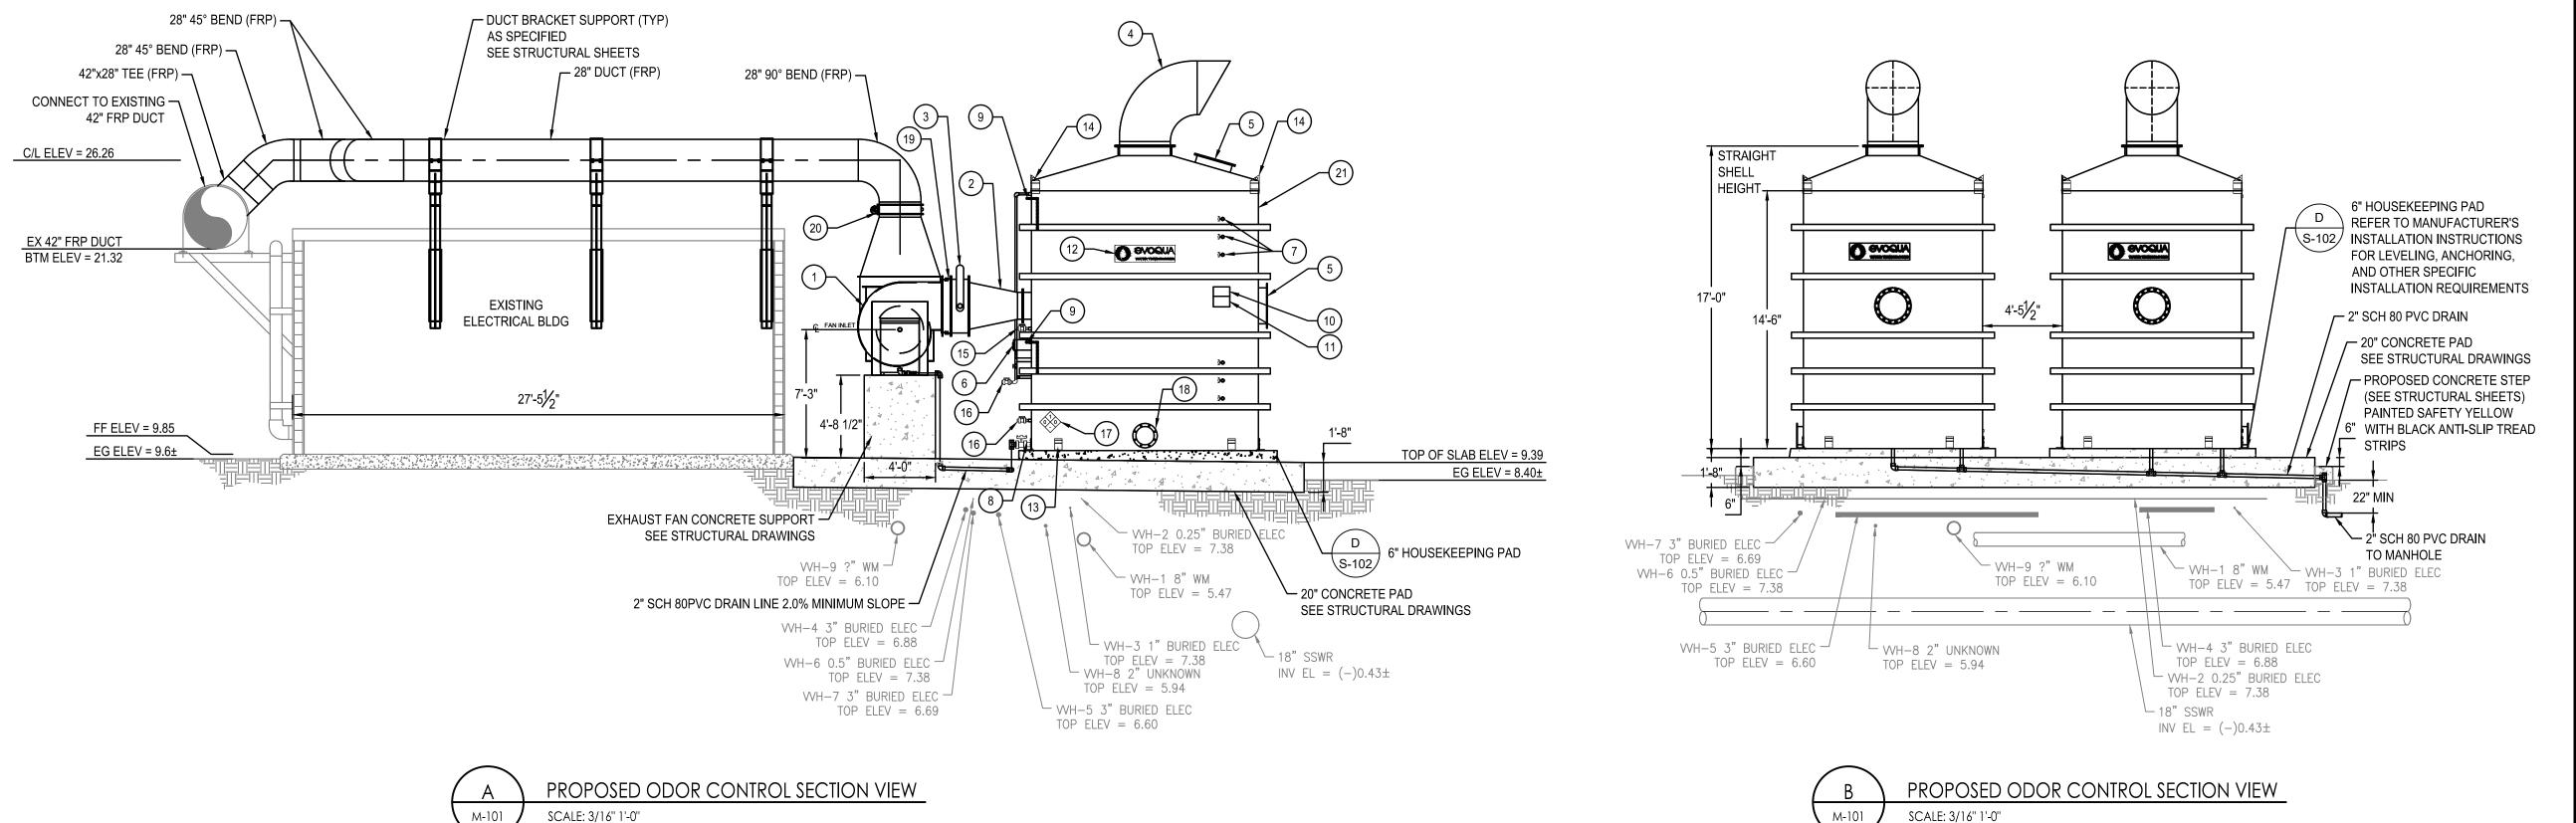



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HYDROGEN SULFIDE PORTABLE ANALYZER CONNECTION SHALL BE A 1" DIAMETER BALL VALVE TAPPED INTO FRP DUCT.

PROVIDE NEW ELECTRICAL CONDUCTOR FROM UNIT TO POWER SOURCE; NEW REFRIGERANT LINE EQUAL OR BETTER THAN EXISTING MATERIAL WHEN FIRST INSTALLED; PROVIDE NEW GROUNDING WIRE FROM UNIT TO GROUNDING TERMINAL; PROVIDE HURRICANE STRAPS AS REQUIRED BY THE FLORIDA BUILDING CODE 2021.

Revision		Ву	Appd	Date
BID SET			SM	NOVEMBER, 2023
Issued		Ву	Appd	Date
File Name: 11697-M-101	MPL	ML	SM	NOVEMBER, 2023

Dwn. Dsgn. Chkd. Date

38819

Permit/Seal

HAROLD E. SCHMIDT, P.E.

Client/Project COLLIER COUNTY PUBLIC UTILITIES

NORTH COUNTY WATER RECLAMATION FACILITY ODOR CONTROL - PHASE II

MECHANICAL PLAN AND SECTION VIEW


Scale Project No. AS SHOWN 177311697 Phase Drawing No.

**BID SET** 13 of 33

M-101

ORIGINAL SHEET - ANSI D

SCALE: 3/16" 1'-0"

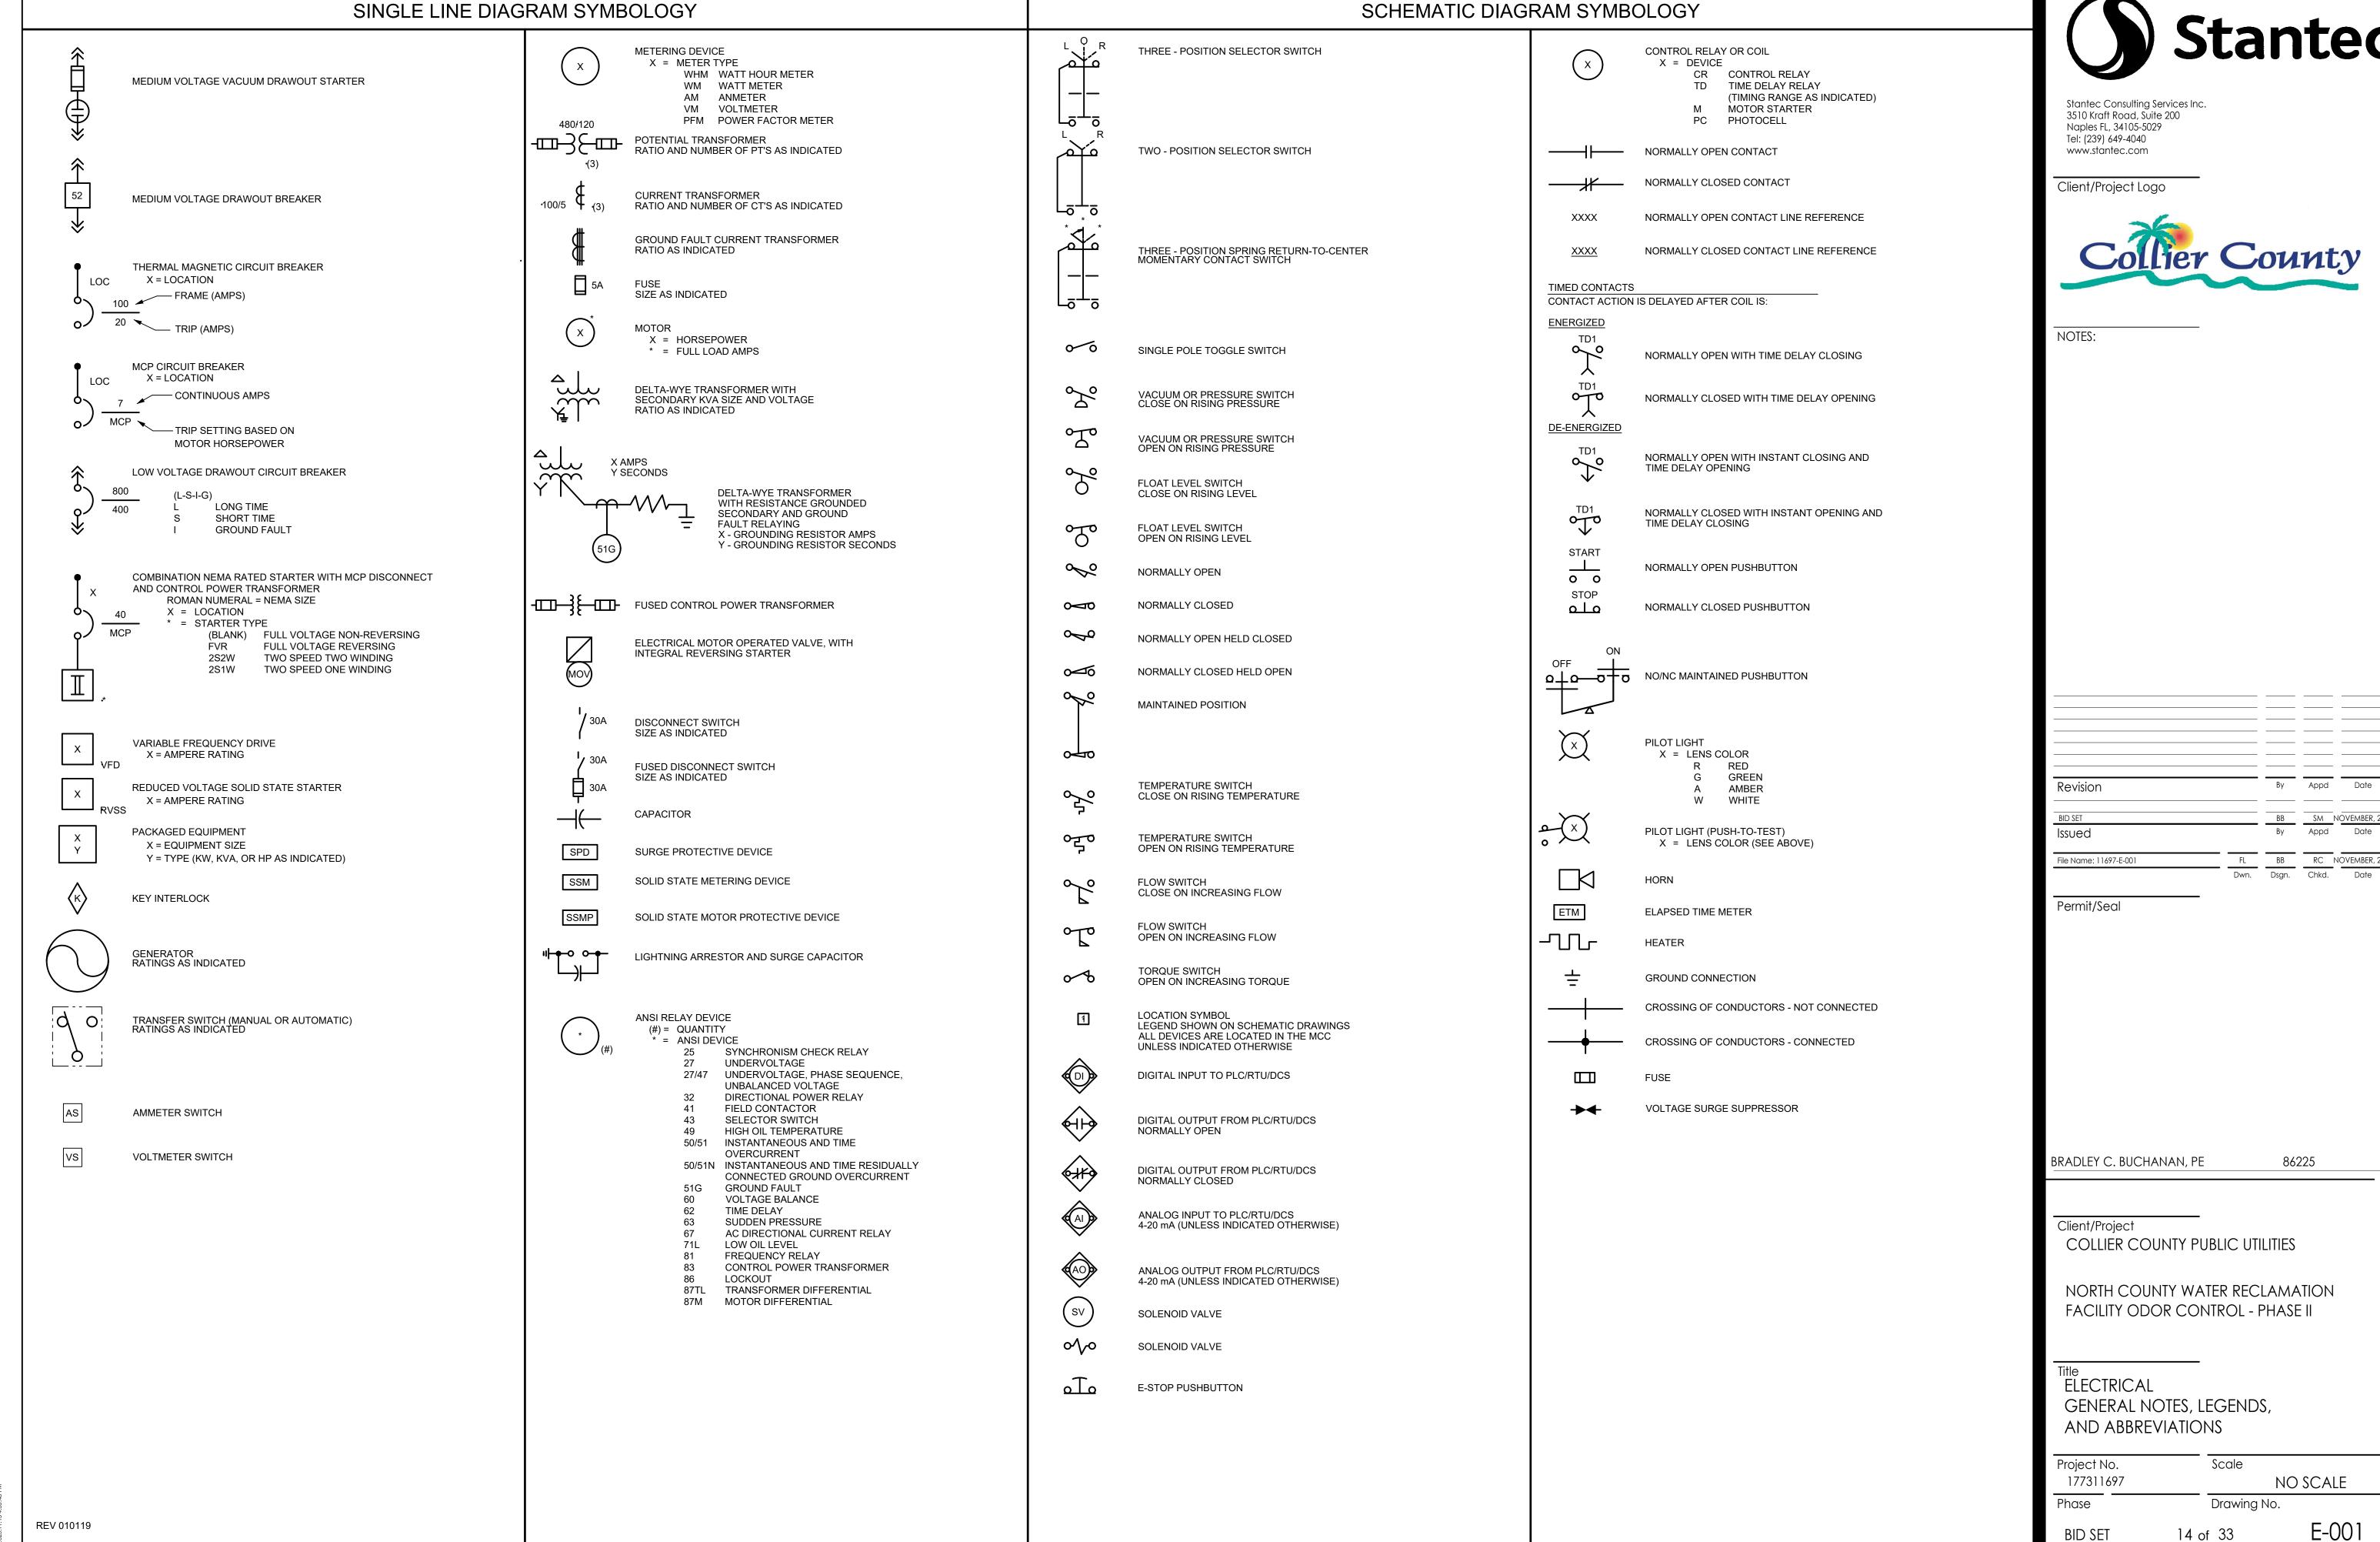

ORIGINAL SHEET - ANSI D

By Appd Date Appd Date

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Revision By Appd Date BB SM NOVEMBER, 2023
By Appd Date Issued File Name: 11697-E-001 Dwn. Dsgn. Chkd. Date

BRADLEY C. BUCHANAN, PE

Permit/Seal

86225

Client/Project COLLIER COUNTY PUBLIC UTILITIES

NORTH COUNTY WATER RECLAMATION FACILITY ODOR CONTROL - PHASE II

ELECTRICAL GENERAL NOTES, LEGENDS, AND ABBREVIATIONS

Scale Project No. 177311697

Phase

**BID SET** 

Drawing No.

NO SCALE

E-002

15 of 33

REV 010119

COMBINATION STARTER

MANUAL MOTOR STARTER

ELECTRICAL ABBREVIATIONS GENERAL ELECTRICAL NOTES	ELE
Accessed A CHANGE OF THE PROPERTY OF THE PROPE	E AND APPLICABLE LOCAL CODES.  RMINAL BOXES AND CONDUIT AWINGS BEFORE STUBBING UP  SALL BE INSTALLED IN A MANNER TO ODITIONS. EXPOSED CONDUIT SHALL WALLS.  ATHE CENTERLINE OF TERMINAL  PMENT SHOWN ON THE DRAWINGS ENGINEER IN WRITING AND THE EY ARE MADE.  WITERIOR OF EXTERIOR WALLS REMET SHALL BE MOUNTED SO AS ENCLOSURE AND THE WALL.  OR SHALL COORDINATE EXACT MINIMUM) AWAY FROM MECHANICAL  ATION.  DETAILS WHETHER OR NOT THEY  E EXPANSION OR EXPANSION AND HOLDINTS, REFER TO THE STRUCTURAL  AGHEIGHT GIVEN ON THE BOTTOM OF THE LUMINAIRE TO THE DHARDWARE SHALL BE SUPPLIED.  SE FROM THE CENTERLINE OF THE ST POSITION TO THE FINISHED FLOOR  INDUIT REPRESENT A SUGGESTED NITS OF ELECTRICAL EQUIPMENT.  BY THE CONTRACTOR TO IC SEQUENCE AND METHOD OF IGS AND/OR SPECIFICATIONS.  ALL BOXES OR SIMILAR EQUIPMENT DUIT.  INECTION TO MOTORS AND OTHER  E TERMINATED AS SHOWN IN DETAIL  BE AS FOLLOWS:  ARE FOR FUTURE ADDITION OF  KER OR STARTER AVAILABLE FOR  L BE SIZED TO PROVIDE SUFFICIENT OF ELECTRICAL DEVICES HE STARTER COIL.  SHALL BE SET ON CONCRETE  NTHE PAD.  SHALL BE GROUND FAULT CIRCUIT  JOING THE PROJECT TO VERIFY THE STANTER COIL.  SHALL BE SET ON CONCRETE  NTHE PAD.  SHALL BE SET ON CONCRETE  NOW SHOW SHALL CONCRETE  THE PAD.  SHALL BE SET ON CONCRETE  NOW SHOW SHALL CONCRETE  THE PAD.  SHALL BE CONCEALED UNLESS  BERS ARE SHOWN. CONTRACTOR  JUNCTION SHOULD BE GIVEN TO NEW  HOWNER'S REQUIREMENTS.  BERS ARE SHOWN. CONTRACTOR  JUNCTION SHOULD BE GIVEN TO NEW  HOWNER'S REQUIREMENTS.  BERS ARE SHOWN. CONTRACTOR  JUNCTION SHOULD BE GIVEN TO NEW  HOWNER'S REQUIREMENTS.  SHALL BE CONCEALED UNLESS. ALL  SENDING THE PROJECT TO VERIFY THE STON THE PANEL SCHEDULES. ALL

LECTRICAL DEMOLITION NOTES

- BIDDING CONTRACTORS SHALL VISIT THE SITE TO ASSESS THE SCOPE OF DEMOLITION, REMOVAL AND MODIFICATION WORK.
- ELECTRICAL CONTRACTOR AND THE OWNER SHALL DE-ENERGIZE ALL WIRING PRIOR TO REMOVAL OF EQUIPMENT, DEVICES, MOTORS INSTRUMENTATION, CONTROL PANELS, ETC. CONTRACTOR SHALL OBTAIN PRIOR APPROVAL FROM THE OWNER.
- EXPOSED RACEWAYS: REMOVE CONDUIT, WIRES, AND BOXES. PATCH TO MATCH EXISTING. FINISH-ALL OPENINGS IN WALLS AND FLOORS.
- CONCEALED CONDUITS IN THE SLAB: REMOVE EXISTING WIRES TO THE EXTENT POSSIBLE AND ABANDON CONDUITS IN THE SLAB. CUT CONDUIT FLUSH AND PATCH THE FLOOR TO MATCH
- CONTROL PANEL: ELECTRICAL CONTRACTOR SHALL DE-ENERGIZE AND REMOVE ALL CONDUIT AND WIRE AS DESCRIBED IN NOTE 2. CONTRACTOR SHALL REMOVE PANELS AS NOTED ON THE CONTRACT DRAWINGS. REFER TO NOTE 4 ABOVE FOR DISPOSITION OF ENCASED CONDUITS.
- MOTOR CONTROL CENTERS: DISCONNECT AND REMOVE ALL CONDUITS AND WIRING TO EXISTING STARTERS AND/OR BREAKERS, PANELBOARDS, BRANCH CIRCUITS, INTERLOCKS AND STATUS WIRING WITHIN MCC. REFER TO SECTION 260000 FOR ADDITIONAL ELECTRICAL DEMOLITION AND REMOVAL REQUIREMENTS.



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BRADLEY C. BUCHANAN, PE

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86225

Client/Project COLLIER COUNTY PUBLIC UTILITIES

NORTH COUNTY WATER RECLAMATION FACILITY ODOR CONTROL - PHASE II

Title ELECTRICAL GENERAL NOTES, LEGENDS, AND ABBREVIATIONS

Scale Project No. 177311697


NO SCALE Drawing No.


16 of 33

E-003

REV 010119 ORIGINAL SHEET - ANSI D **BID SET** 

Phase

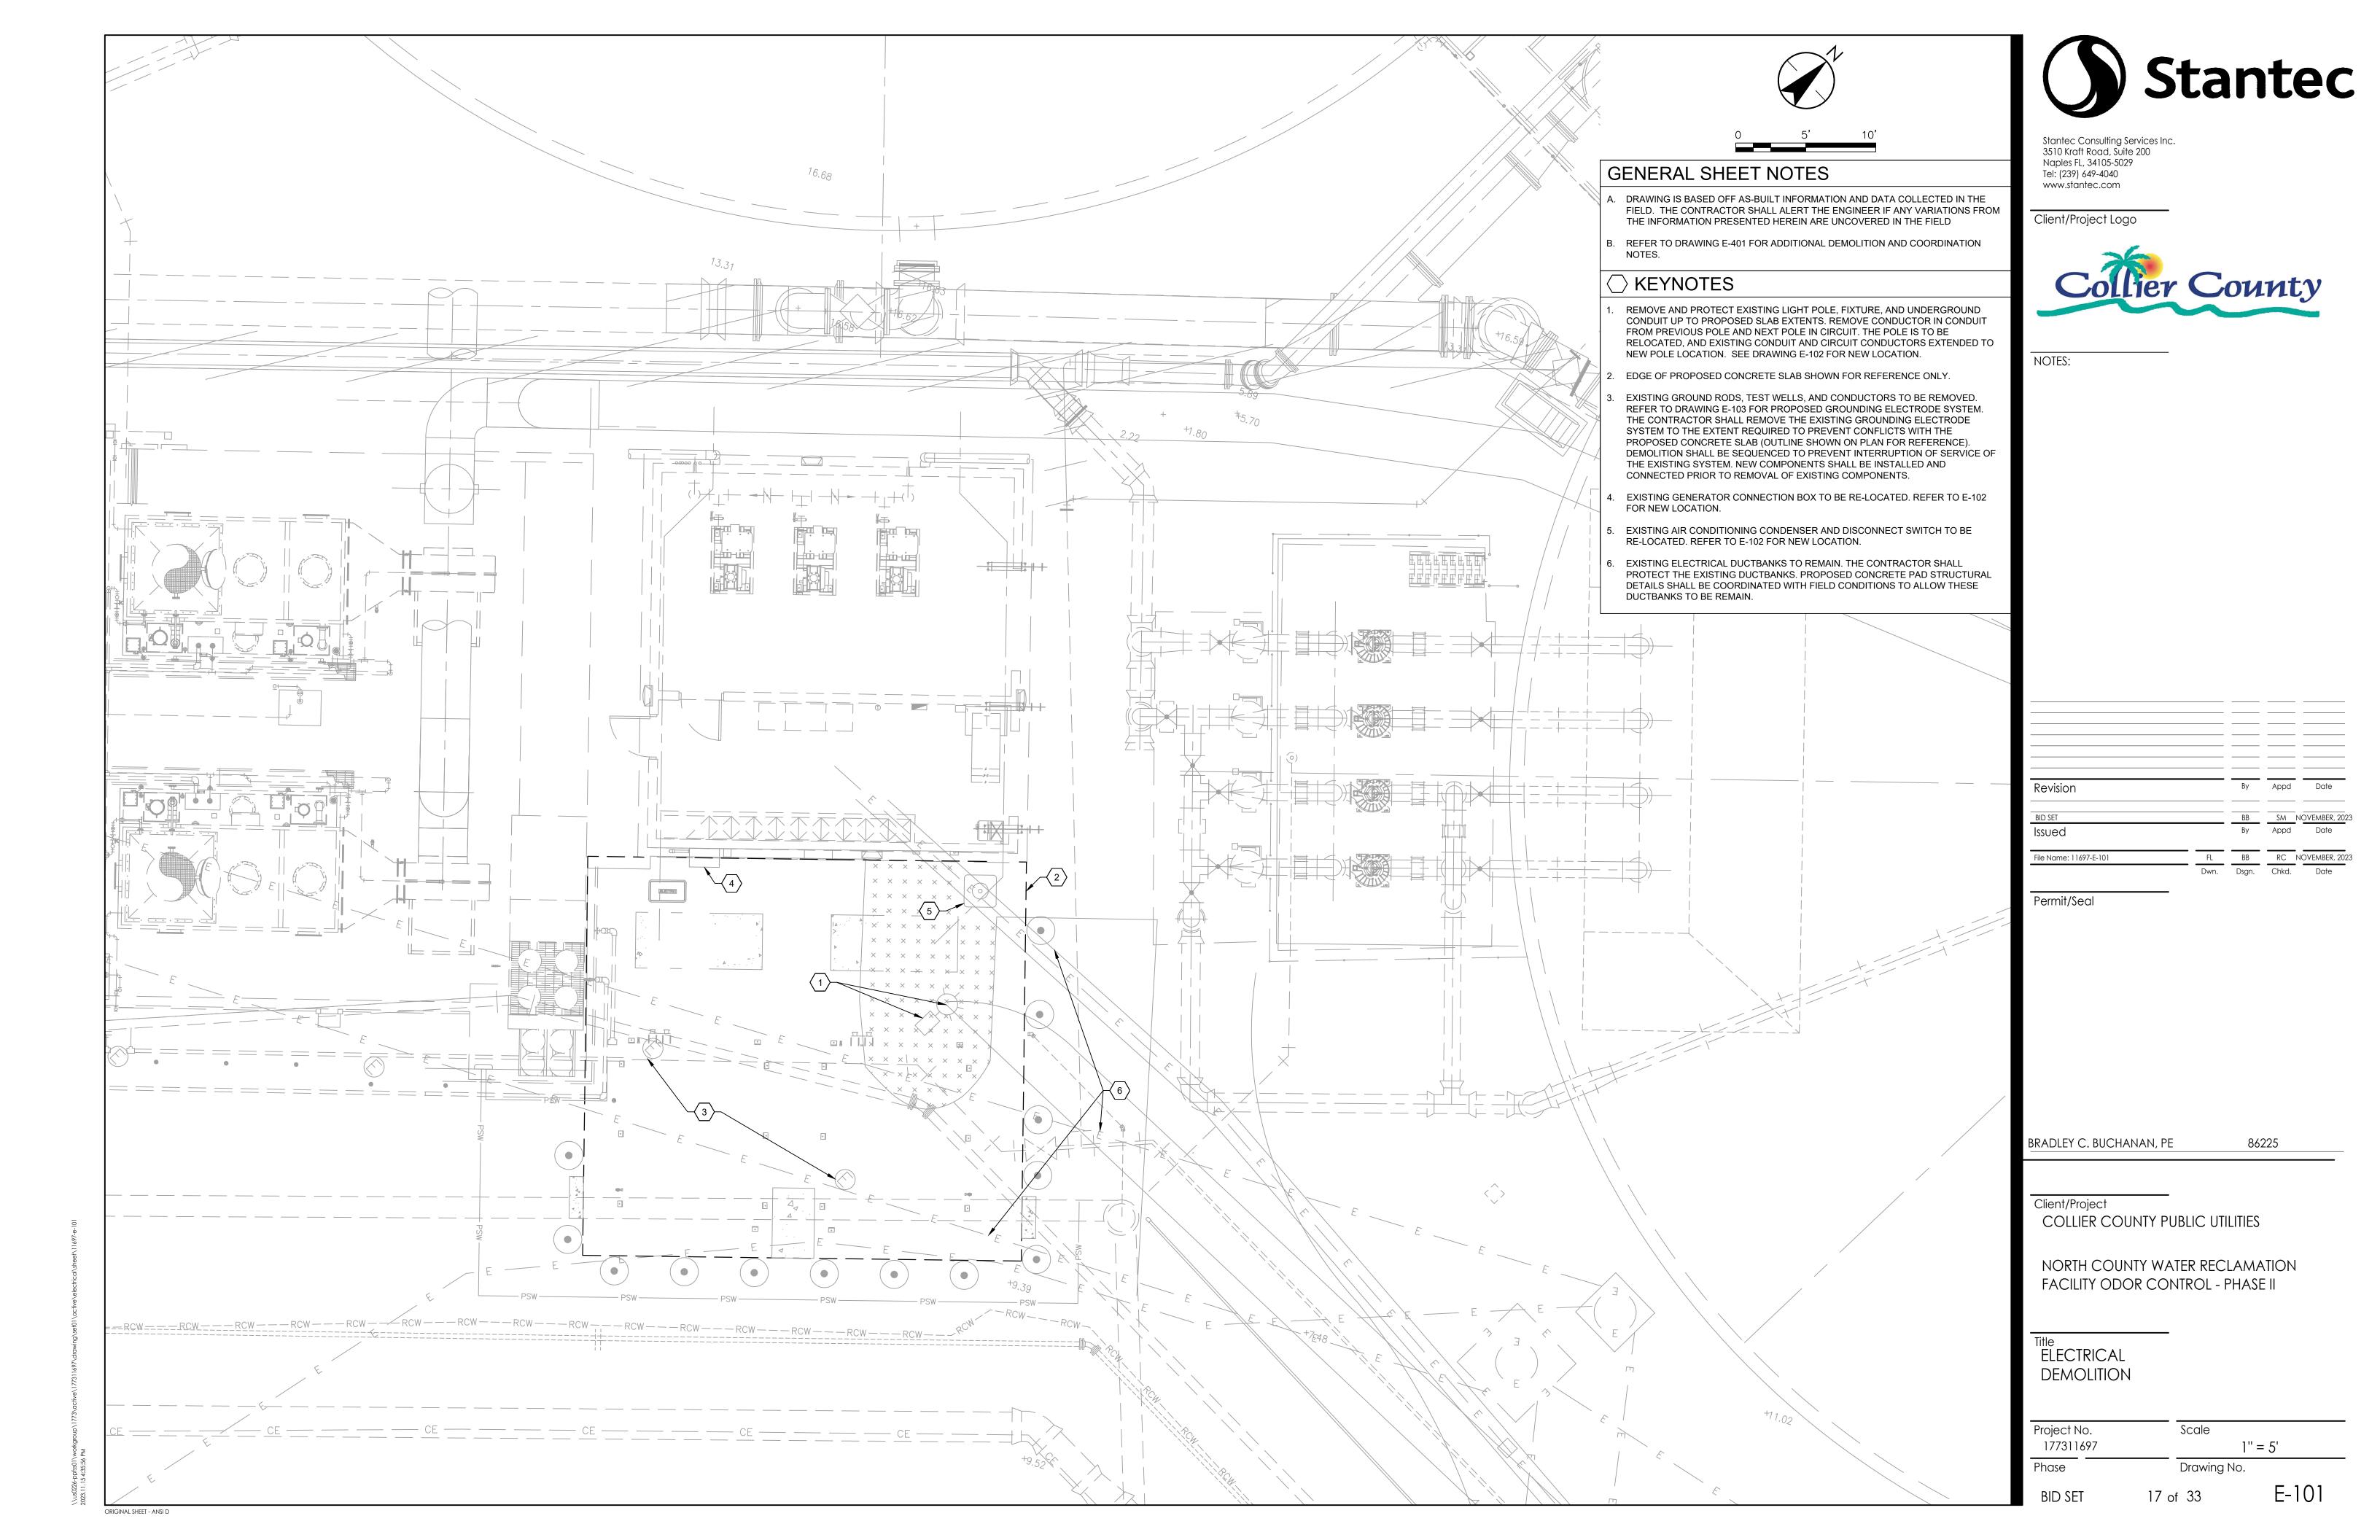

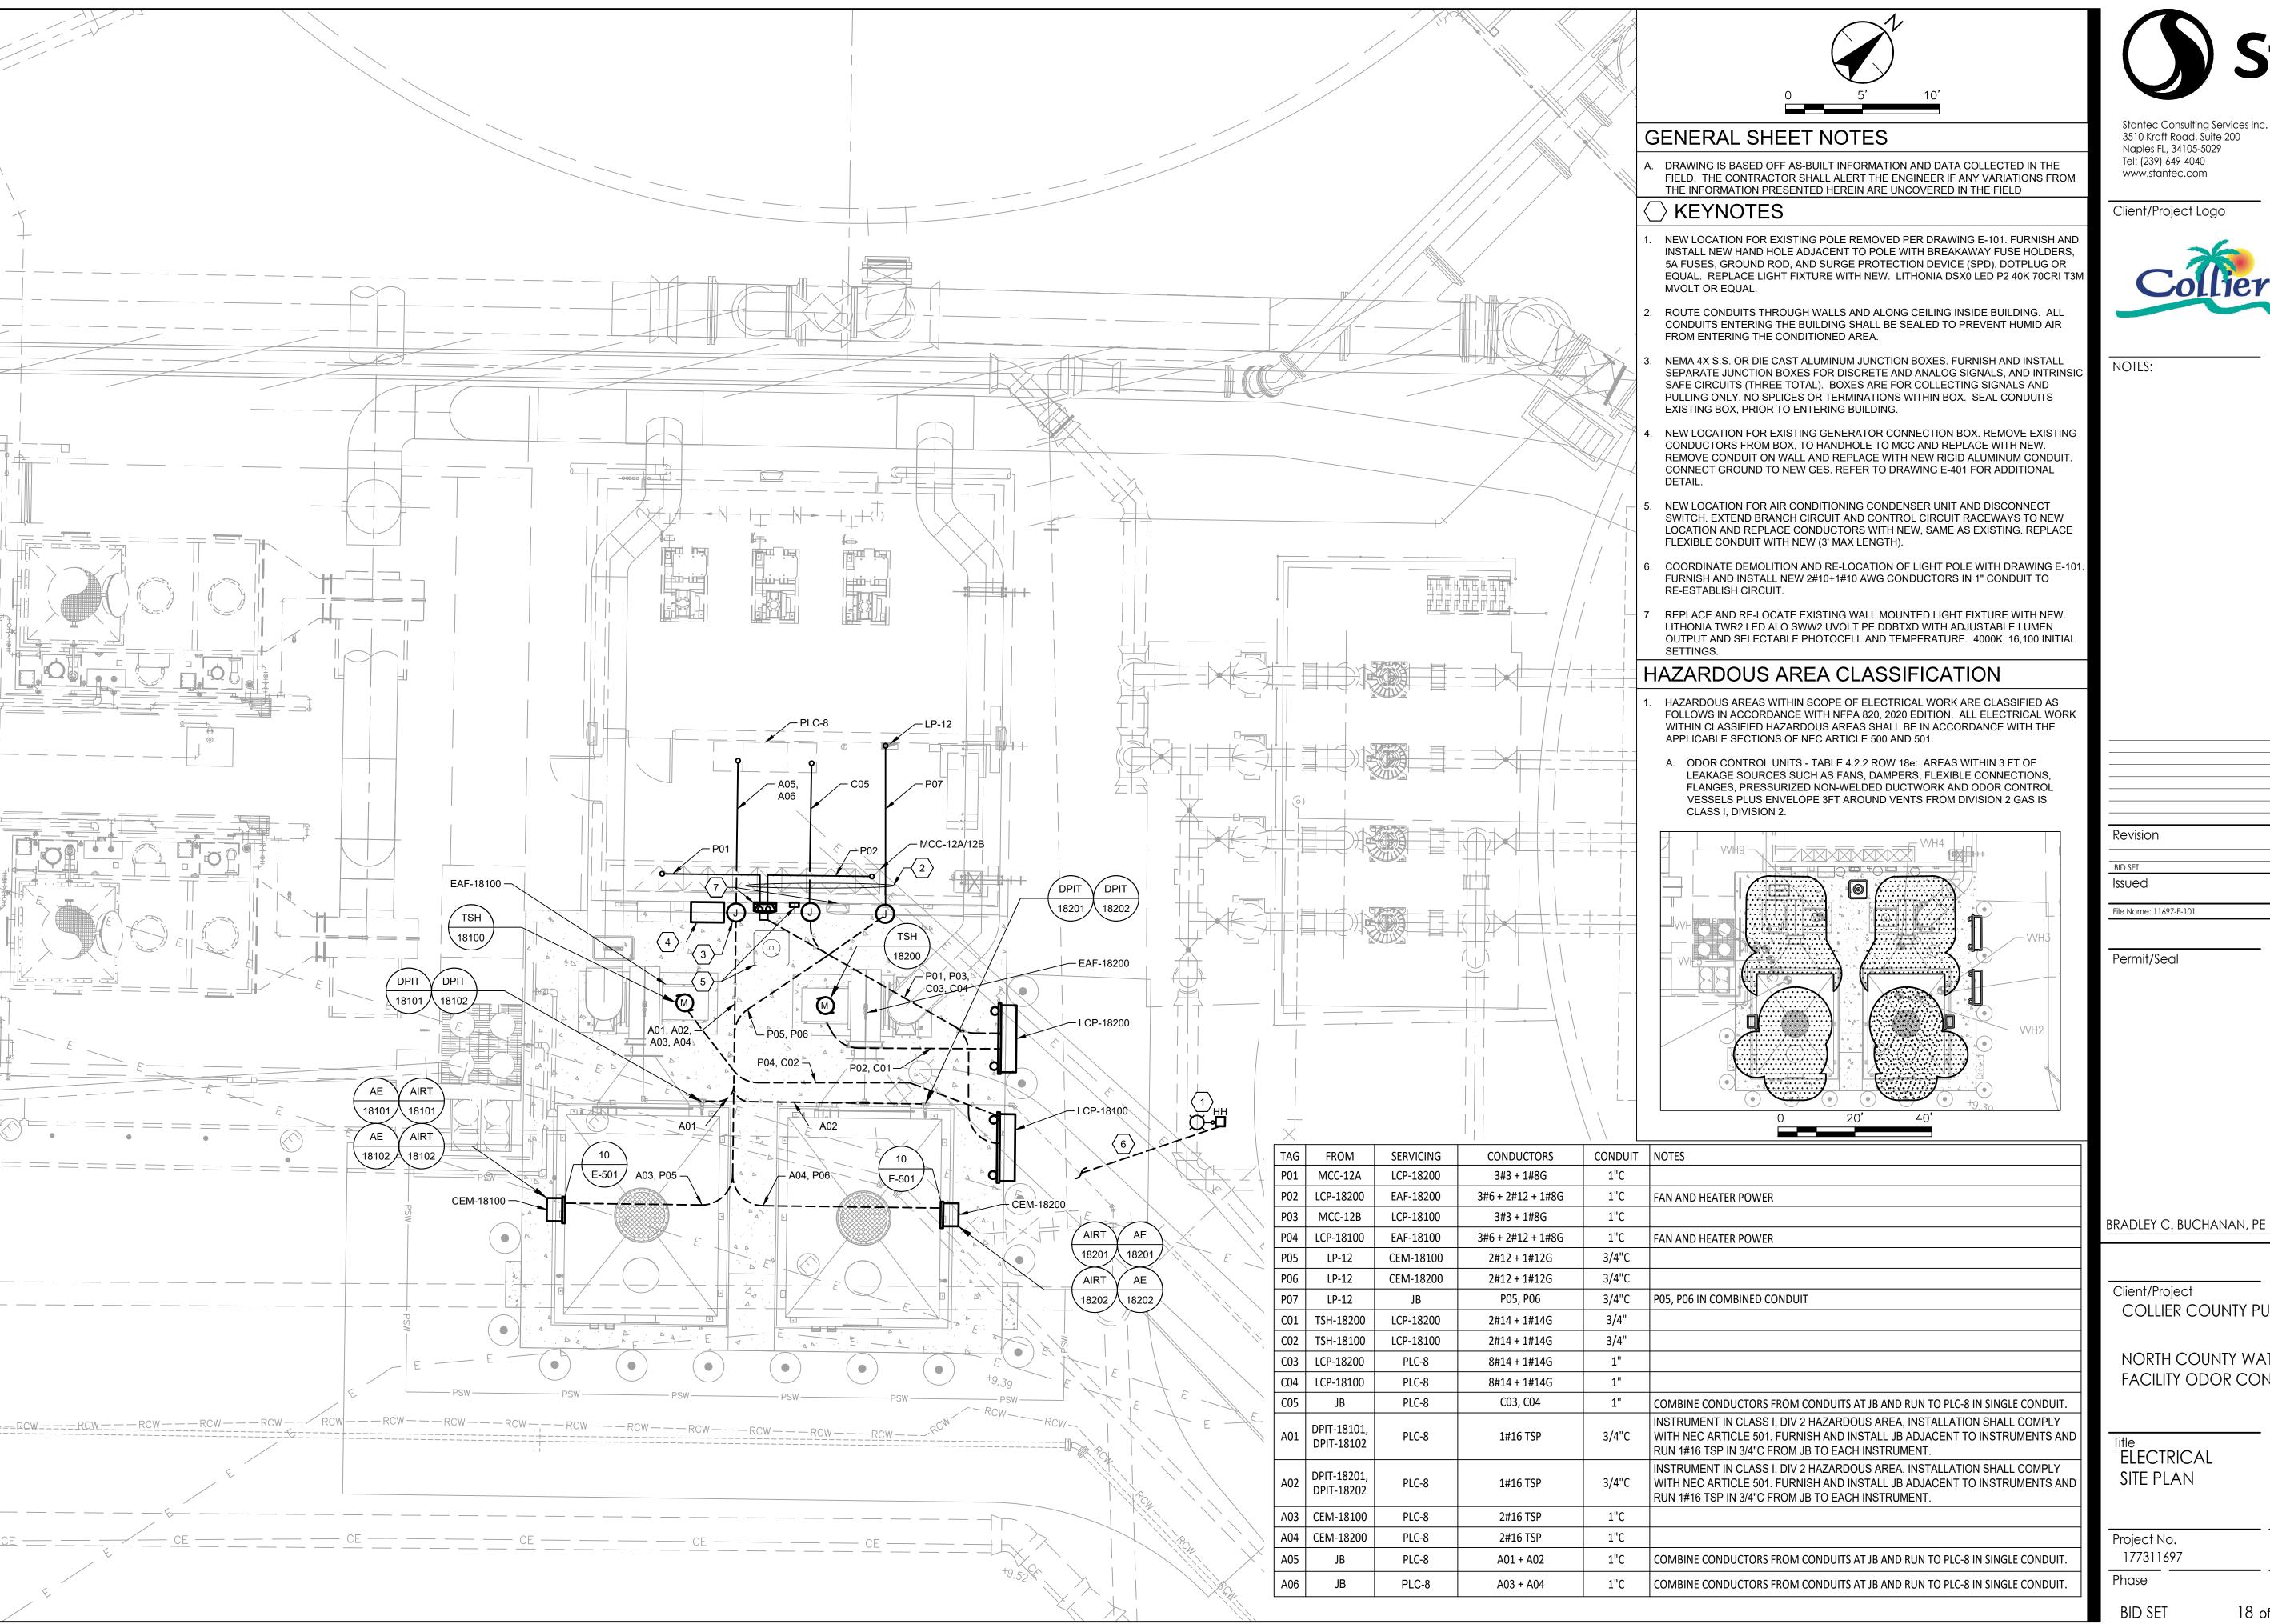

ORIGINAL SHEET - ANSI D



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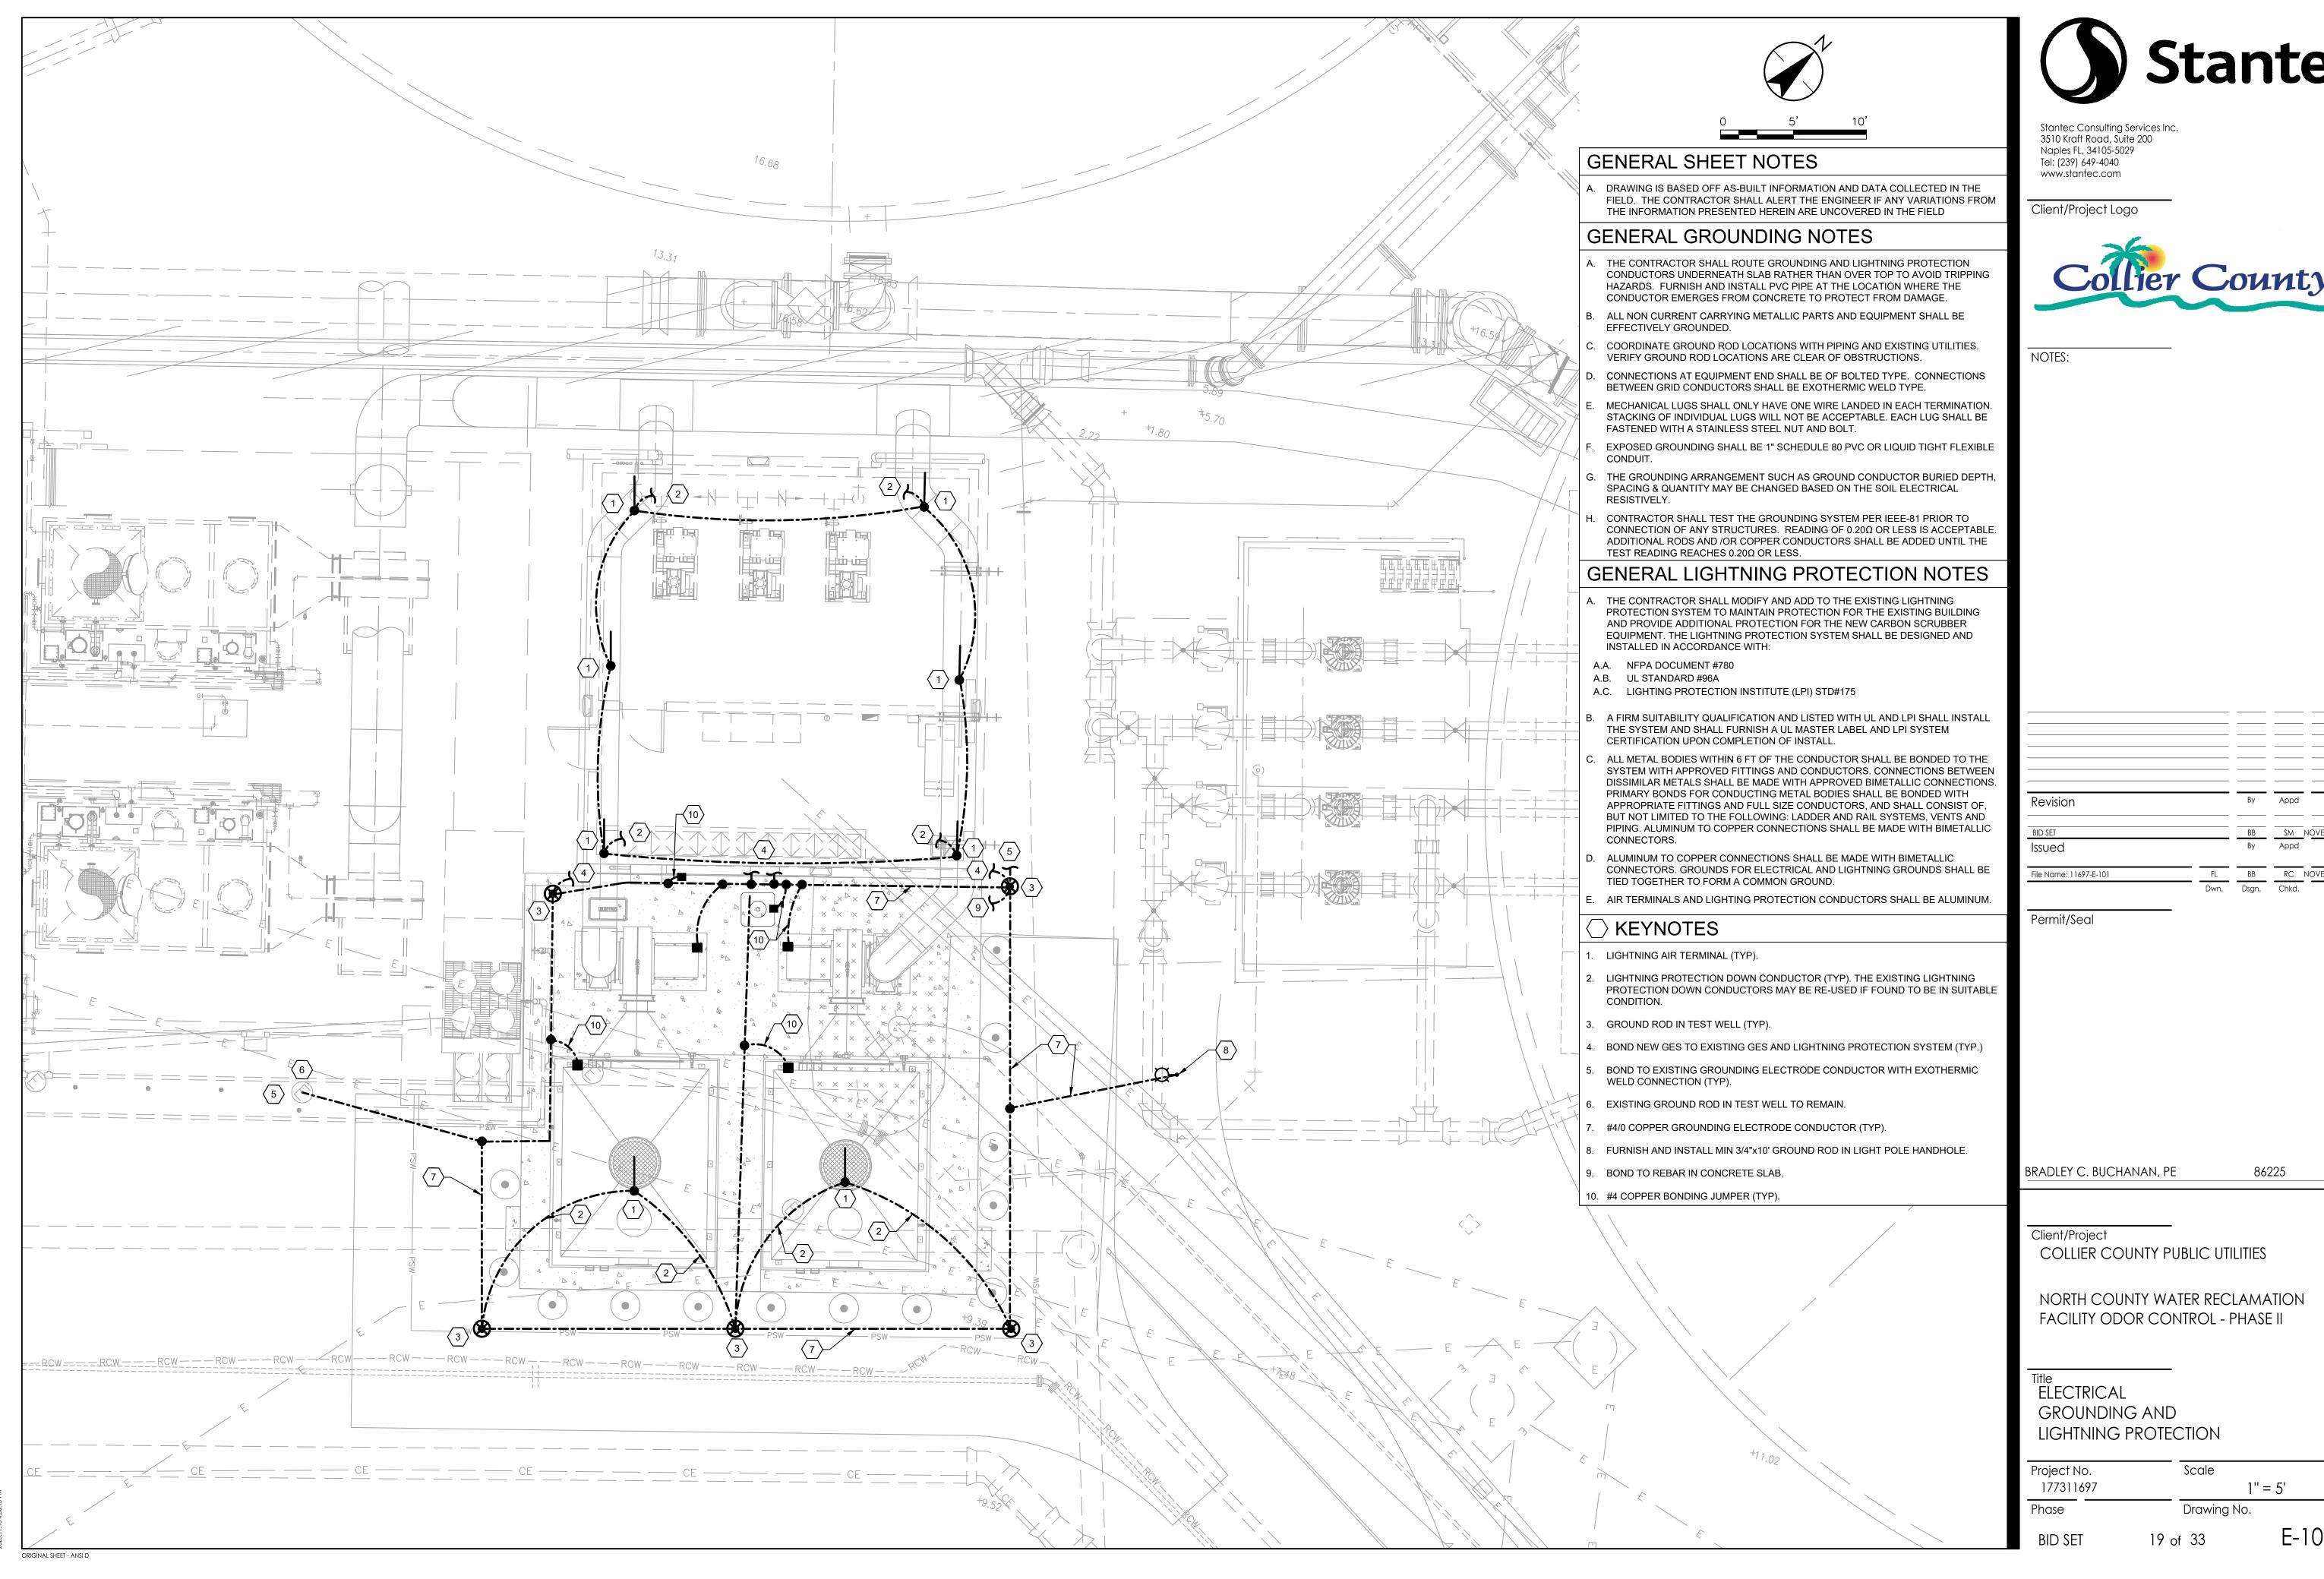
NORTH COUNTY WATER RECLAMATION FACILITY ODOR CONTROL - PHASE II

ELECTRICAL SITE PLAN

Project No. Scale 177311697 Phase Drawing No.

18 of 33

86225







# 

- 1. REMOVE AND PROTECT EXISTING LIGHT POLE AND FIXTURE. THIS LIGHT POLE IS TO BE RE-LOCATED PER DRAWING E-102.
- 2. REMOVE EXISTING HAND HOLE. REMOVE EXISTING CONDUIT AND CONDUCTORS FROM PREVIOUS POLE AND NEXT POLE IN CIRCUIT AND EXTEND TO NEW LOCATION. PORTIONS OF THE EXISTING UNDERGROUND CONDUIT MAY BE RE-USED IF IT IS NOT IN CONFLICT WITH THE PROPOSED FOUNDATION FOR THE NEW ODOR CONTROL EQUIPMENT OR OTHER NEW WORK. REPLACE CONDUCTORS WITH NEW #10AWG.
- 3. EXISTING GROUND ROD AND TEST WELL TO BE REMOVED. REFER TO GROUNDING PLAN FOR MODIFICATIONS AND CONNECTIONS TO THE EXISTING GES. MODIFICATIONS TO THE EXISTING GES SHALL SEQUENCED TO PREVENT INTERRUPTION OF SERVICE.
- EXISTING HAND HOLE FOR THE GENERATOR CONNECTION BOX. EXTEND HAND HOLE TO SIT FLUSH WITH TOP OF NEW SLAB.
- 5. RE-LOCATE EXISTING GENERATOR CONNECTION BOX. REFER TO PLAN DRAWING E-102 FOR ADDITIONAL DETAIL. AS PART OF RE-LOCATING THIS PANEL, REPLACE ALL EXPOSED CONDUIT ON WALL WITH NEW RIGID ALUMINUM CONDUIT AND REPLACE CONDUCTORS BETWEEN GENERATOR CONNECTION BOX AND MCC.
- 6. HVAC CONTRACTOR SHALL RE-LOCATE AIR CONDITIONER CONDENSER AND ALL REQUIRED AUXILIARIES (REFRIGERANT LINE, POWER AND CONTROL CONDUCTORS AND CONDUITS, DISCONNECT, HURRICANE STRAPS, ETC.) REFER TO PLAN DRAWING FOR PROPOSED LOCATION. THE CONTRACTOR SHALL FURNISH TEMPORARY AIR CONDITIONING FOR THE BUILDING ELECTRICAL ROOM WHILE THE AIR CONDITIONER IS TAKEN OUT OF SERVICE.
- 7. EXISTING GROUNDING ELECTRODE CONNECTIONS. ALL EXISTING GROUNDING ELECTRODE CONNECTIONS FOR EQUIPMENT AND LIGHTNING PROTECTION ARE TO BE MAINTAINED. REFER TO GROUNDING PLAN ON DRAWING E-103 FOR DETAIL.
- 8. EXISTING LIGHTNING PROTECTION SYSTEM TO BE MODIFIED TO PROTECT PROPOSED PIPING AND ODOR CONTROL UNITS. REFER TO DRAWING E-103 FOR
- 9. REMOVE EXISTING LIGHT FIXTURE AND REPLACE WITH NEW IN LOCATION SHOWN. REFER TO PLAN DRAWING FOR FIXTURE TYPE AND LOCATION.
- 10. REMOVE LIGHT FIXTURE AND REPLACE WITH STAINLESS STEEL OR ALUMINUM JUNCTION BOX. EXTEND BRANCH CIRCUIT AND CONDUCTORS (2#12 + 1#12G IN 3/4"C) ALONG WALL TO NEW FIXTURE LOCATION. SECURE NEW FIXTURE TO WALL IN ACCORDANCE WITH MANUFACTURER RECOMMENDATIONS USING STAINLESS STEEL HARDWARE.



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NOTE

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 By
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 NOVEMBER, 202

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BRADLEY C. BUCHANAN, PE

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Client/Project
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NORTH COUNTY WATER RECLAMATION FACILITY ODOR CONTROL - PHASE II

20 of 33

Title
ELECTRICAL
COORDINATION NOTES

Project No. 177311697

Scale

NO SCALE


Drawing No.

86225


BID SET

Phase


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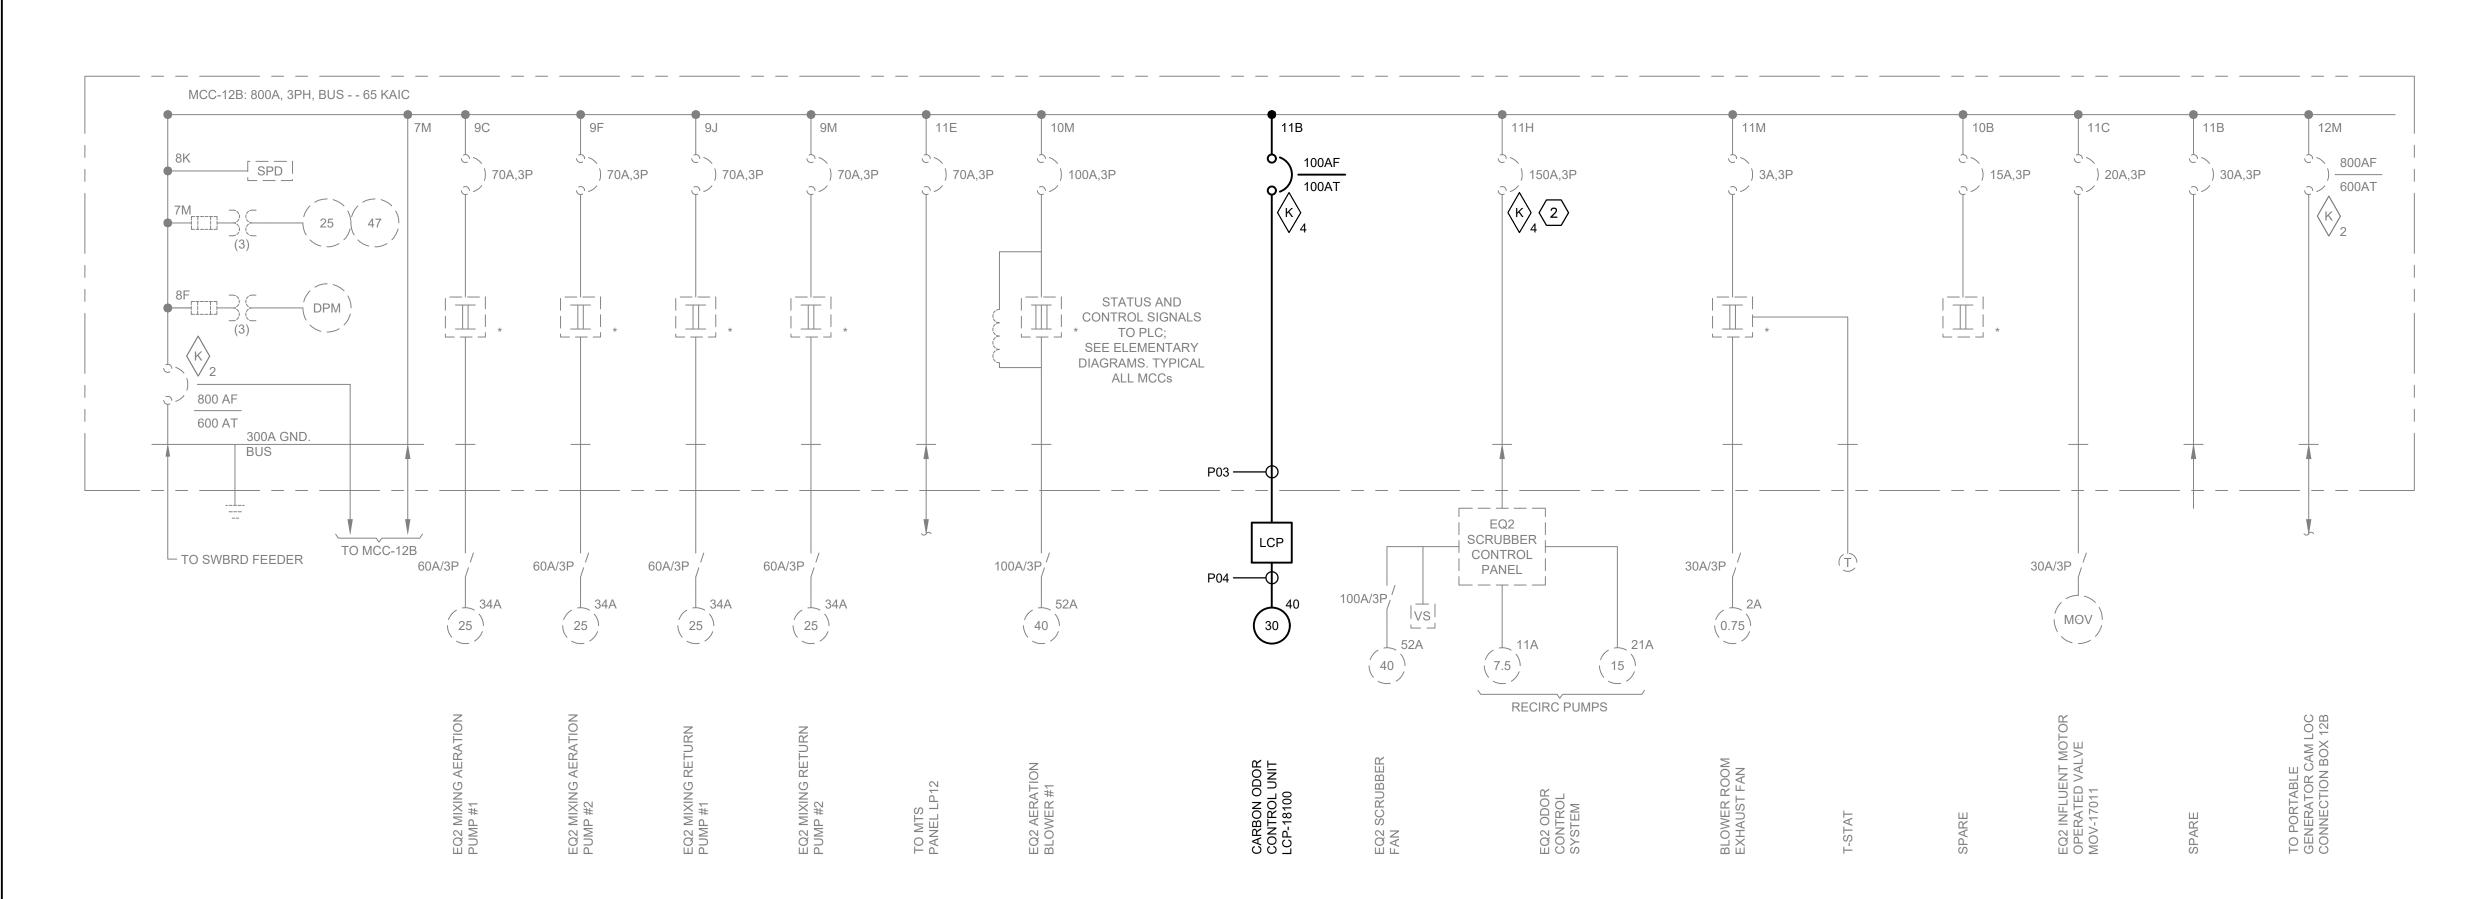

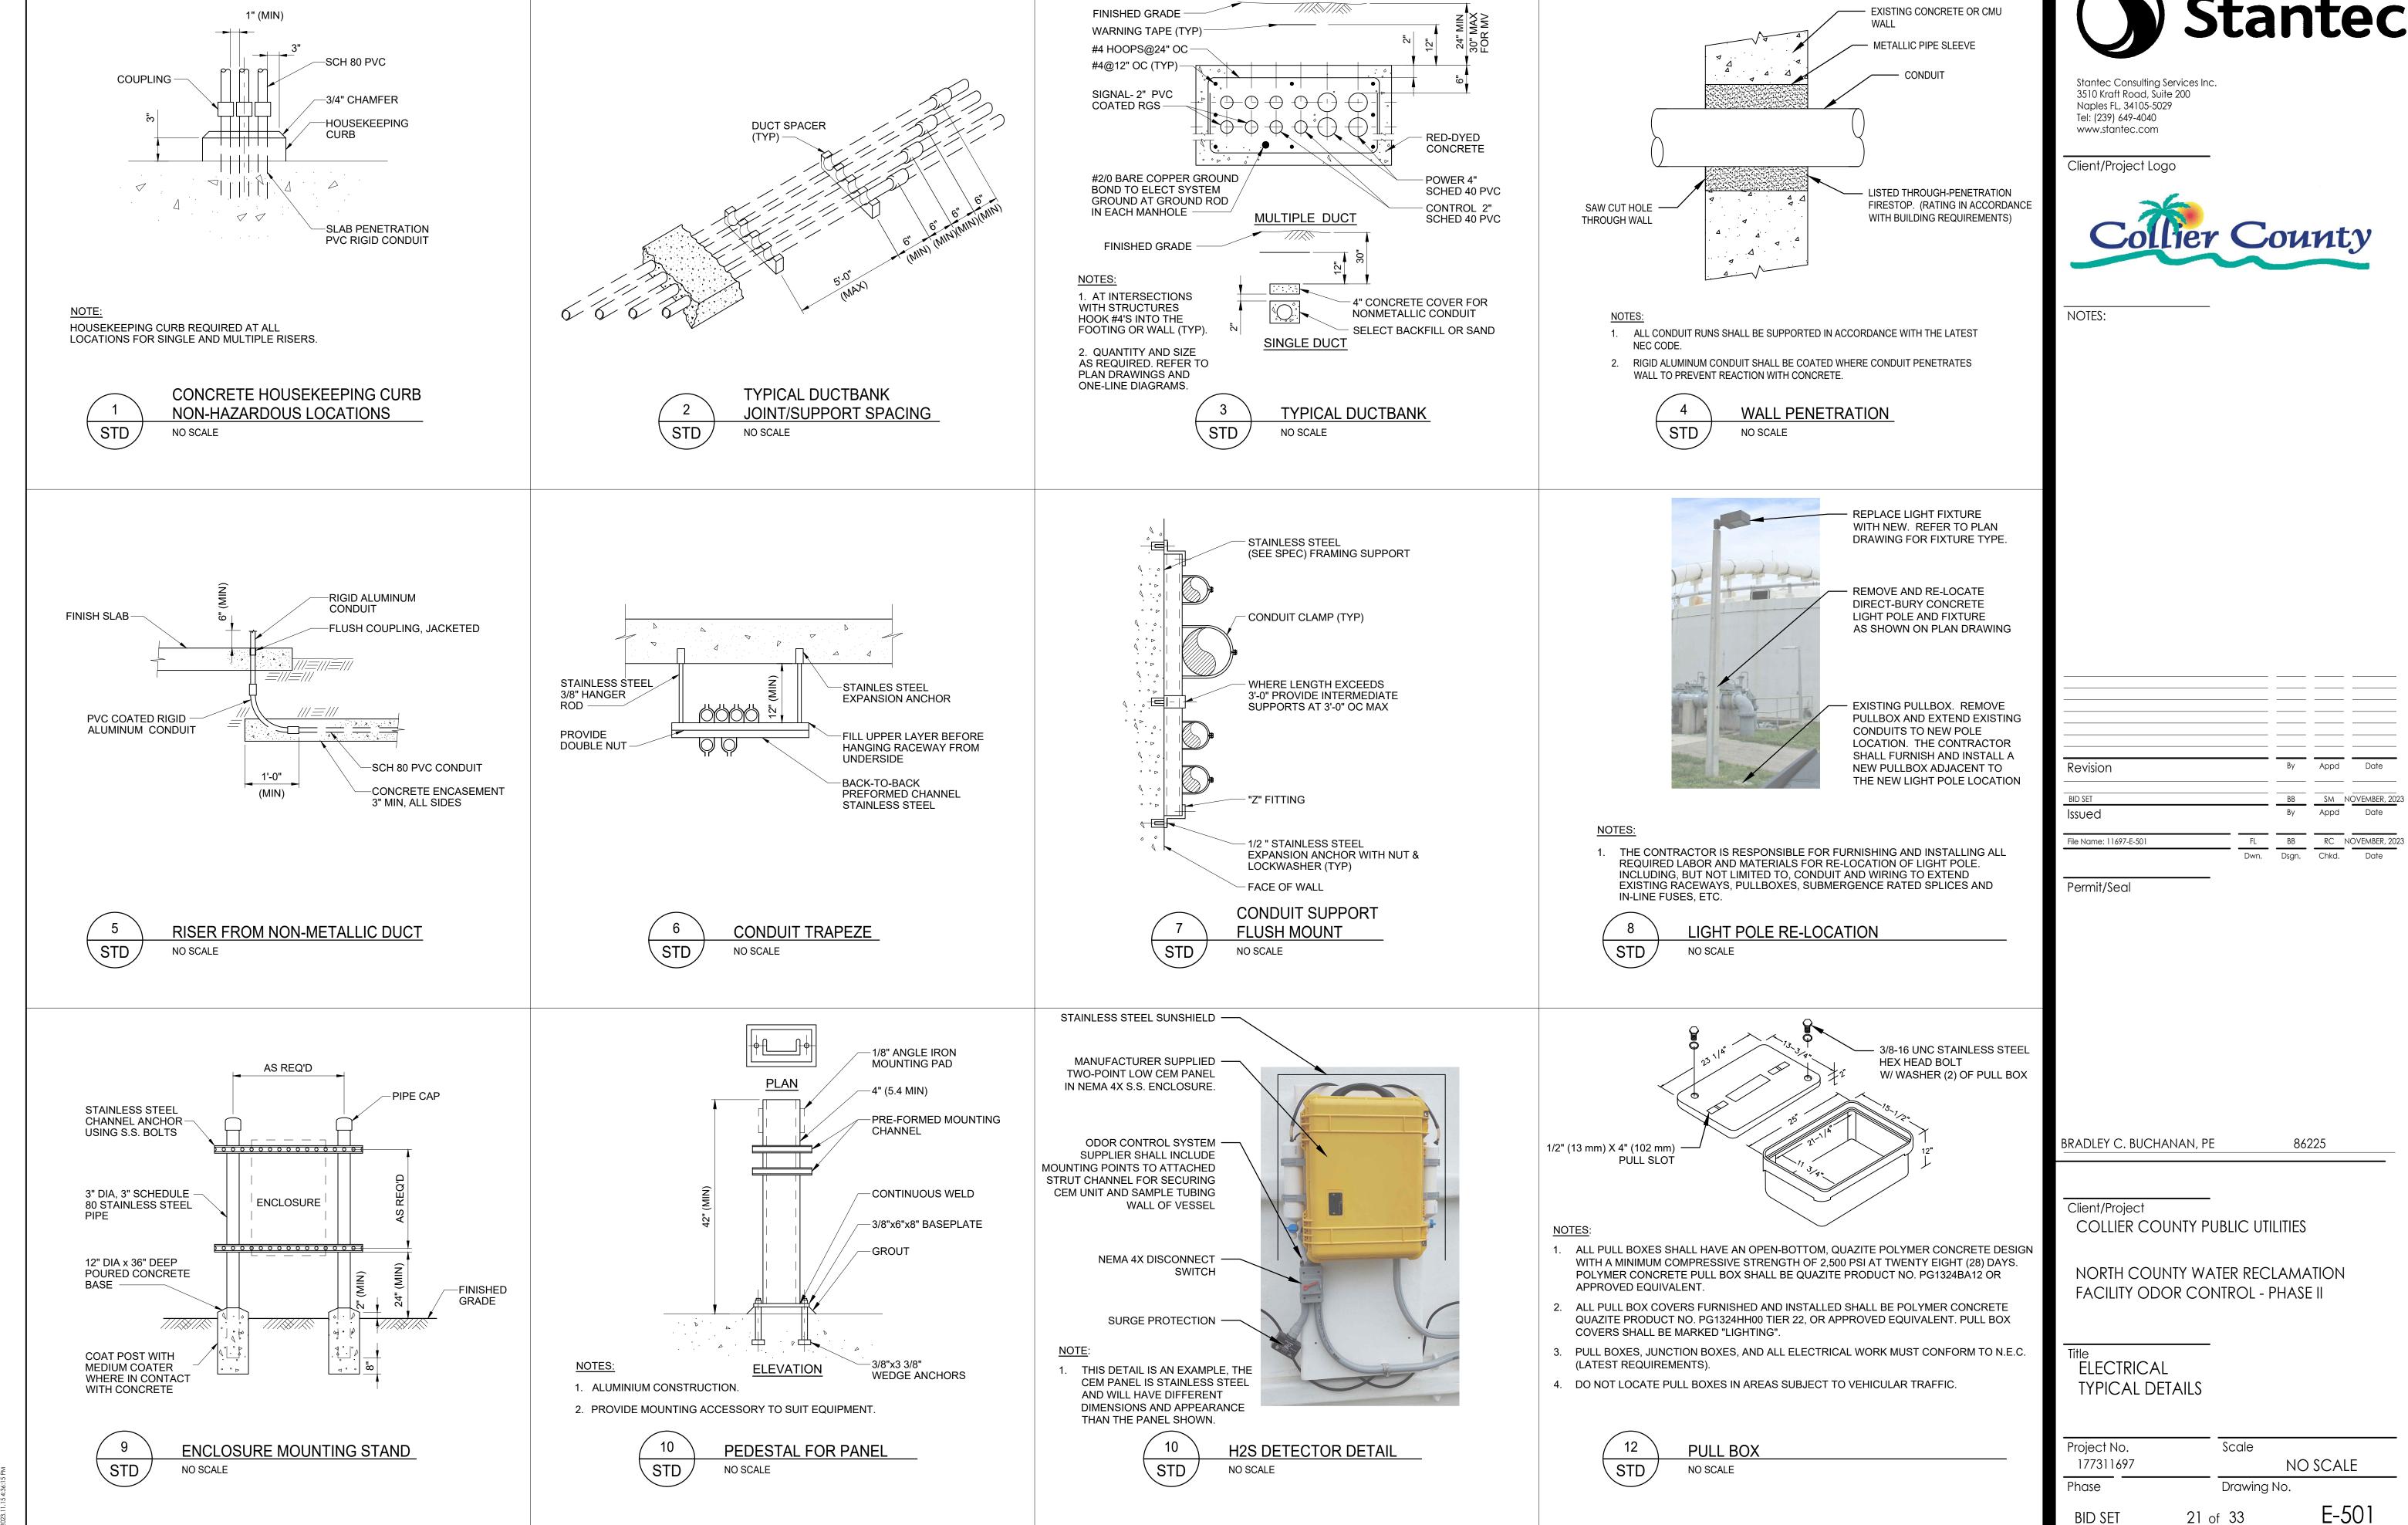
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**BID SET** 22 of 33 E-502



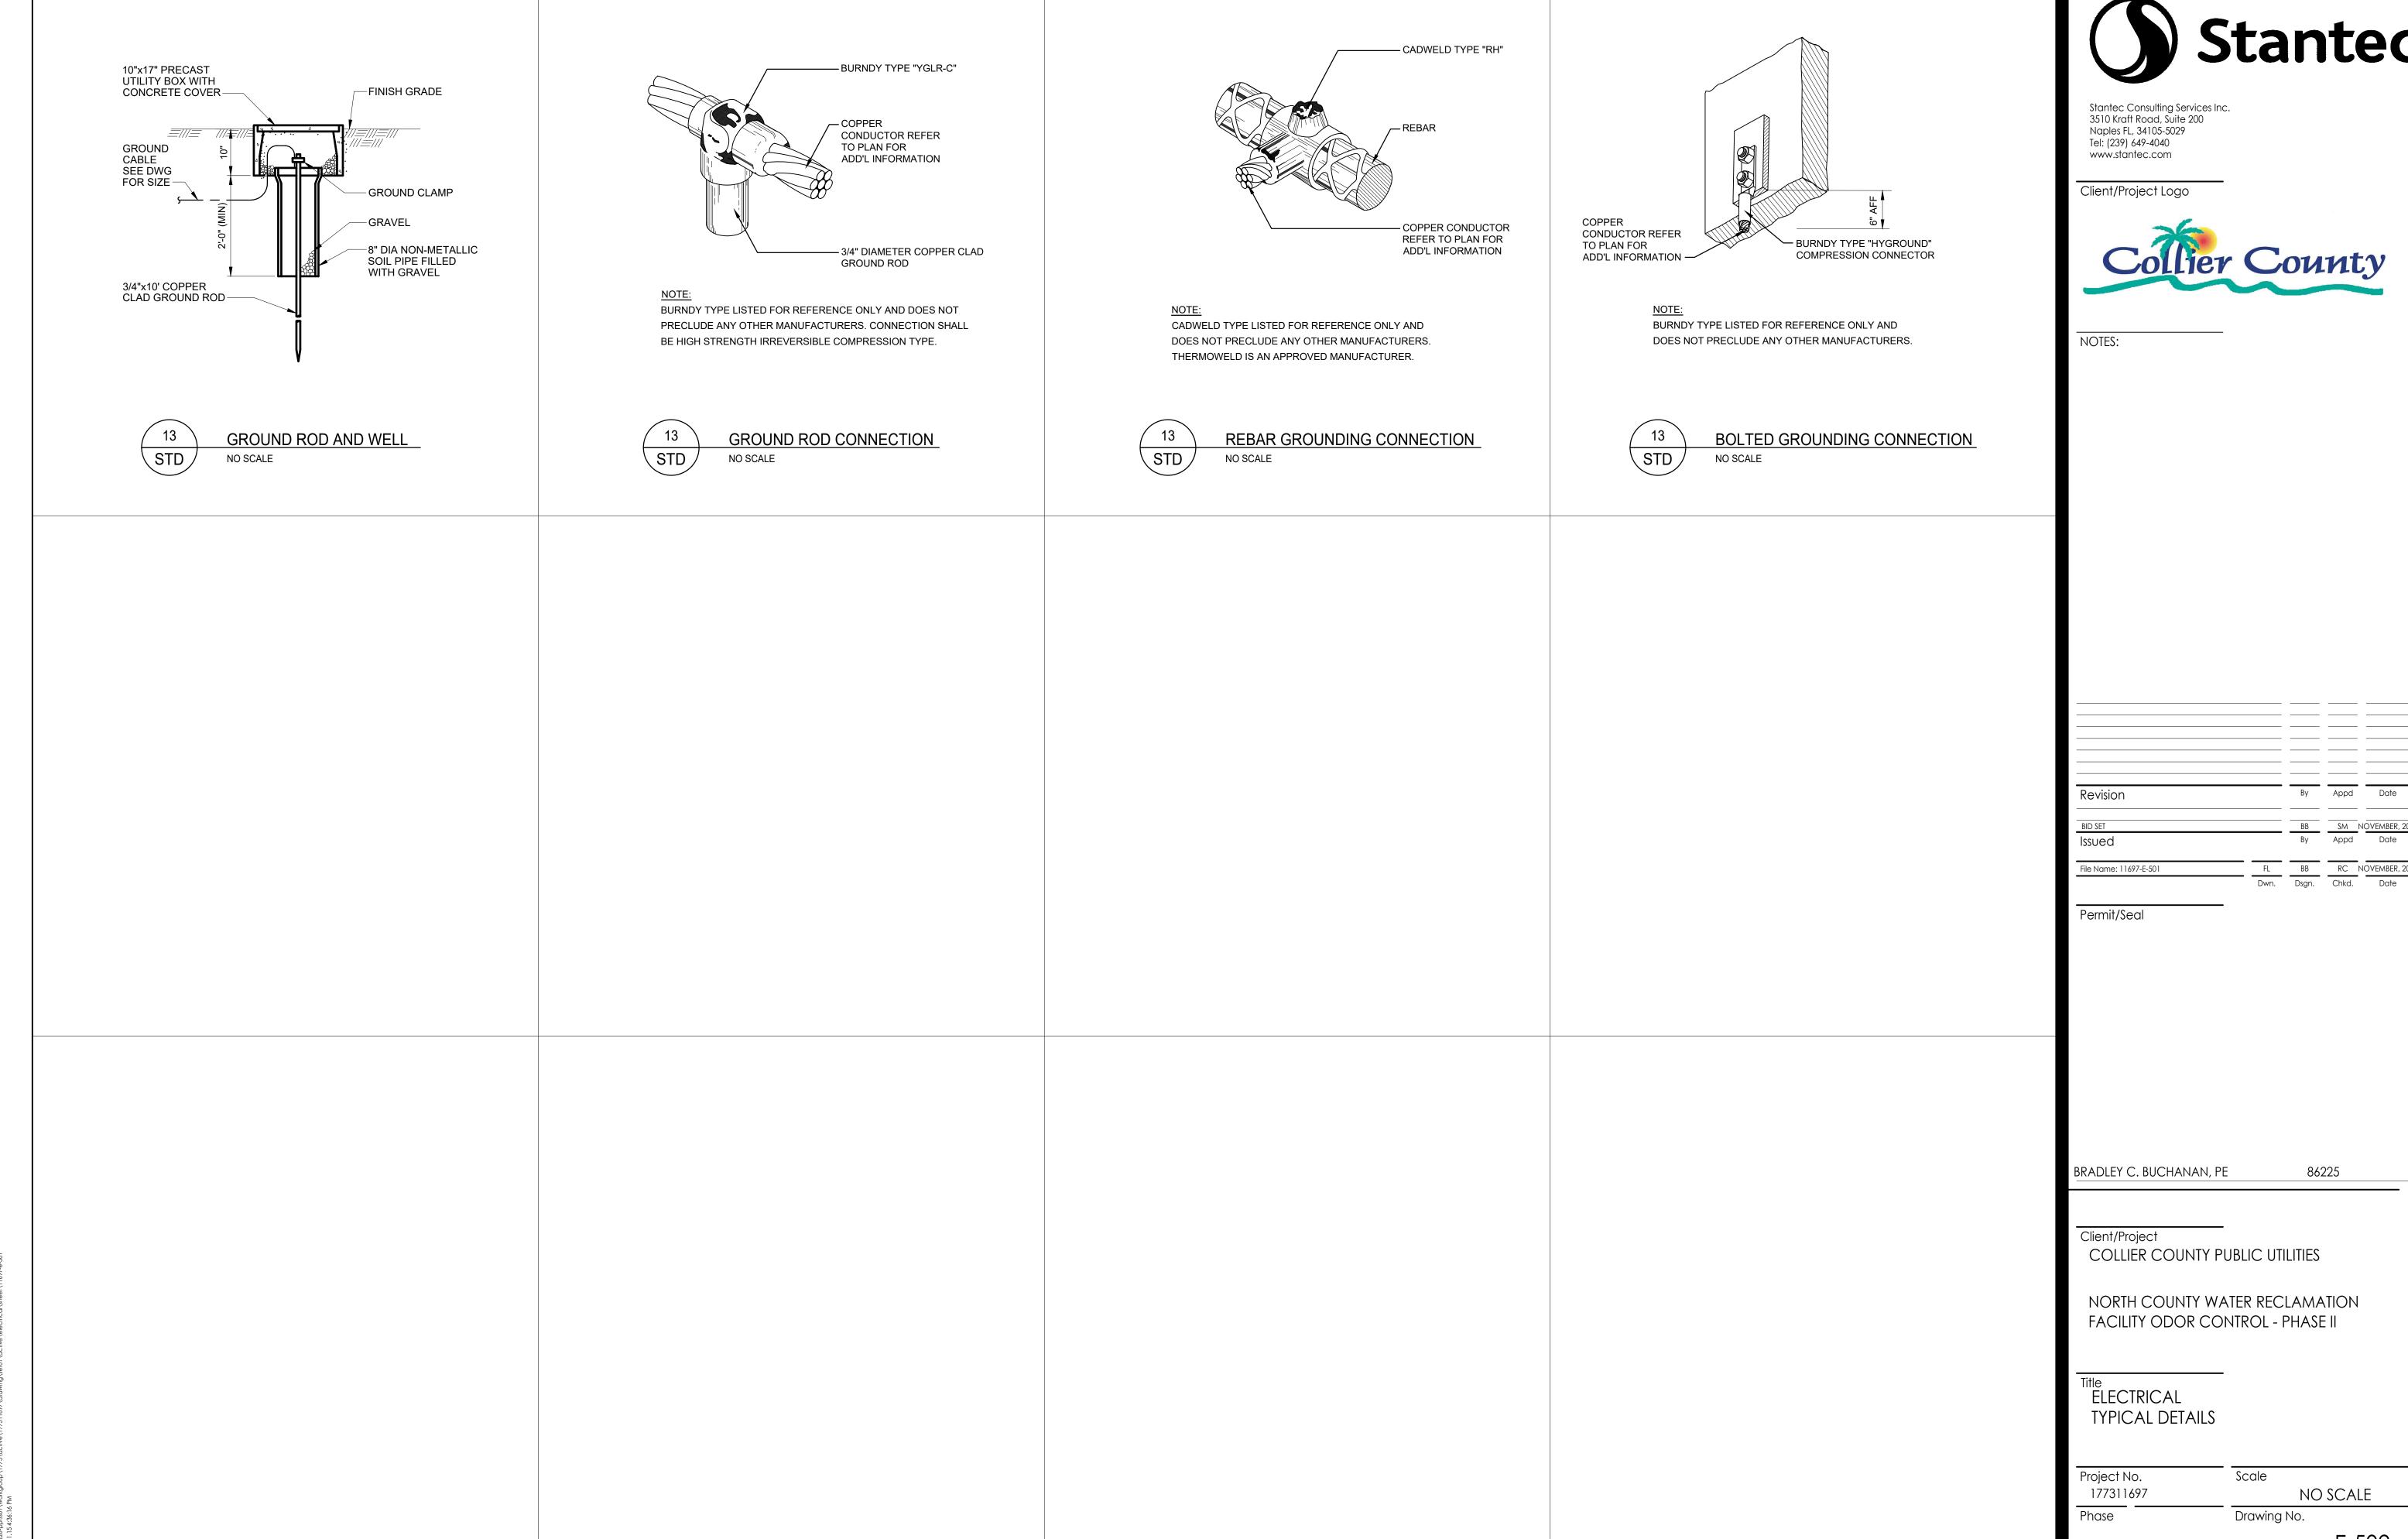

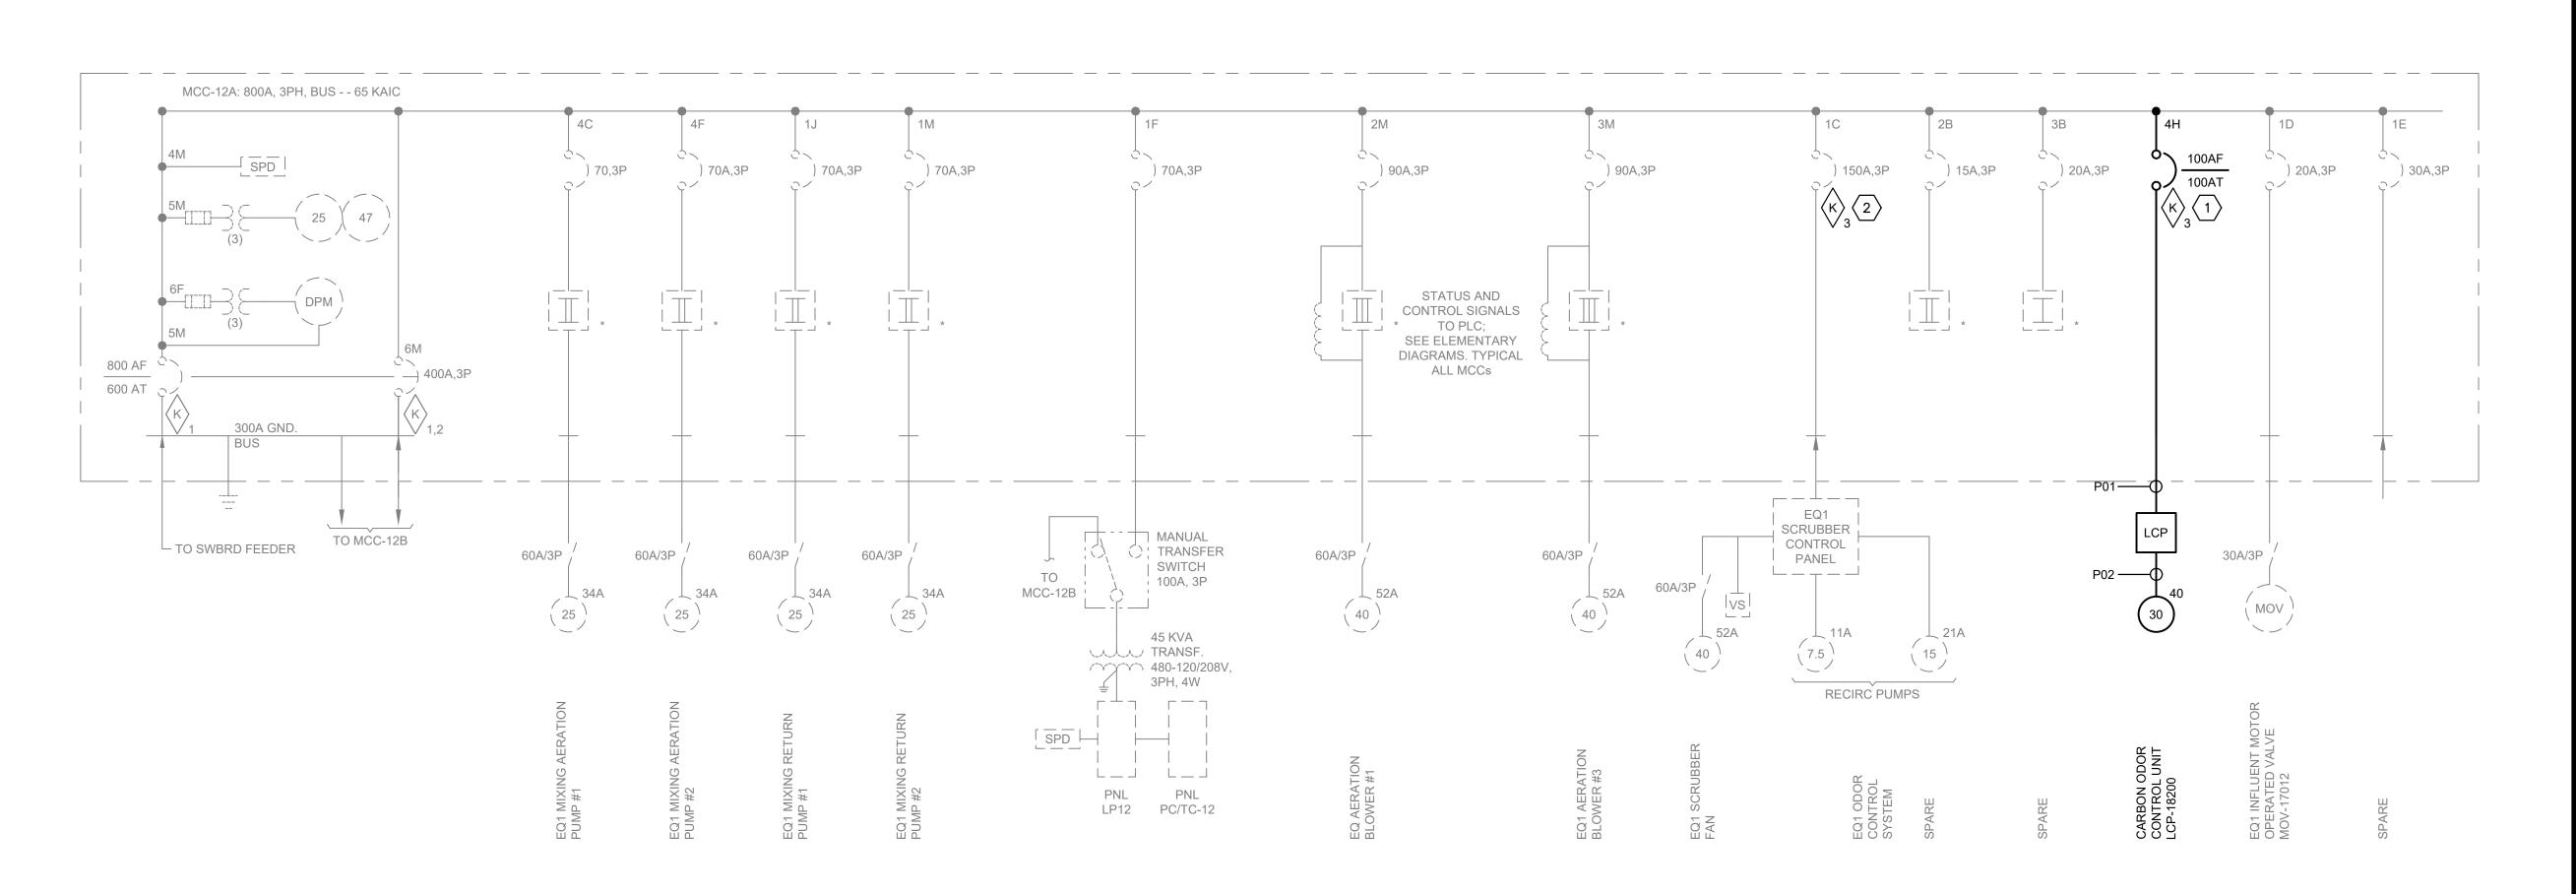

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DRAWING IS BASED OFF AS-BUILT INFORMATION AND DATA COLLECTED IN THE FIELD. THE CONTRACTOR SHALL ALERT THE ENGINEER IF ANY VARIATIONS FROM THE INFORMATION PRESENTED ARE UNCOVERED IN THE FIELD.

### **KEYED NOTES:**

- FURNISH AND INSTALL FEEDER BREAKER FOR NEW ODOR CONTROL UNIT IN EMPTY SPACE AS SHOWN.
- FURNISH AND INSTALL A KIRK KEY INTERLOCK SYSTEM TO PREVENT SIMULTANEOUS OPERATION WITH EXISTING ODOR CONTROL UNITS. NEW CARBON SCRUBBERS HAVE SMALLER LOAD THAN EXISTING. TOTAL MAXIMUM OPERATING LOAD REMAINS UN-CHANGED. REFER ONE-LINE DRAWING FOR

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BRADLEY C. BUCHANAN, PE

86225

Dwn. Dsgn. Chkd.

Client/Project COLLIER COUNTY PUBLIC UTILITIES

NORTH COUNTY WATER RECLAMATION FACILITY ODOR CONTROL - PHASE II

Title ELECTRICAL ONE LINE DIAGRAMS MCC-12A/12B

Phase

Scale Project No. NO SCALE 177311697 Drawing No.

**BID SET** 23 of 33 E-601

		MCC-12A LOAD CALCULATION							
_ [	TAG	LABEL	MOTOR HP	CONNECTED KVA	DIVERSITY KVA				
$\langle 2 \rangle$	1C	ODOR CONTROL 1	62.5	66.92	66.92				
	1D	MOV 17012	-	2.71	2.71				
	1E	(BLANK)	-	0	0				
	1F	PNL LP12	-	36.00	36				
	1J	EQ1 RETURN PUMP #1	25	27.09	27.09				
	1M	EQ1 RETURN PUMP #2	25	27.09	27.09				
	2B	SPARE	-	0.00	0				
	2M	EQ AERATION BLOWER #1	40	43.23	43.23				
	3B	SPARE	-	0	0				
	3M	EQ AERATION BLOWER #1	40	43.23	43.23				
	4C	EQ1 MIXING/AERATION PUMP #1	25	27.09	27.09				
[	4F	EQ1 MIXING/AERATION PUMP #2	25	27.09	27.09				
$\langle$ 1 $\rangle\langle$ 2 $\rangle$ [	4H	CARBON SCRUBBER 1	30	31.87	0				
	4M	TVSS	-	0	0				
	5M	MAIN FEEDER BREAKER; MAIN 1 OF 2	-	0	0				
	6C	ELR & LDR RELAYS	-	0	0				
	6F	METERING COMPARTMENT	-	0	0				
	6M	TIE BREAKER TO MCC-12B	-	0	0				
		TOTAL		332.32	300.45				
		25% LARGEST MOTOR		10.81	10.81				
		TOTAL NEC LOAD		343.13	311.26				
		MCC-12A TOTAL AMPS @480V		413	374				
		MCC-12A/12B COMBINDED AMPS @480V		775	680				
L									

TAG	LABEL	MOTOR HP	CONNECTED KVA	DIVERSIT
7M	MAIN FEEDER BREAKER; MAIN 2 OF 2	-	0	0
8C	ELR & LDR RELAYS	-	0	0
8F	METERING COMPARTMENT	-	0	0
8K	TVSS	-	0	0
8M	MAIN LUGS TIE TO MCC-12A	-	0	0
9C	EQ2 MIXING/AERATION PUMP #1	25	27.09	27.09
9F	EQ2 MIXING/AERATION PUMP #2	25	27.09	27.0
9J	EQ2 RETURM PUMP #1	25	27.09	27.0
9M	EQ2 RETURM PUMP #2	25	27.09	27.0
10B	SPARE	-	0	0
10M	EQ AERATION BLOWER #2	40	43.23	43.2
11B	CARBON SCRUBBER 2	30	31.87	0
11C	MOV 17011	-	2.71	2.7
11D	(BLANK)	-	0	0
11E	PNL LP12	-	36.00	0
11H	EQ1 ODOR CONTROL SYSTEM	62.5	66.92	66.9
11L	BLOWER ROOM EXHAUST FAN	0.75	1.33	1.33
11M	(BLANK)	-	0	0
12M	PORTABLE GENERATOR CAM LCOK BREAKER 800AF/600AT	-	0	0
	TOTAL		290.42	222.5
	25% LARGEST MOTOR		10.81	0.00
	TOTAL NEC LOAD		301.23	222.5
	MCC-12B TOTAL AMPS @480V		362	268
			<u> </u>	

MCC-12B LOAD CALCULATION

	POWER FACTOR CORRECTION	POWER FACTOR CORRECTION							POWER FACTOR CORRECTION			
1	2	3	4	5	6	7	8	9	10	11	12	
1C	2В	3B	4C	5A	6C	7A	8C	9C	10B	11B		
1D				_						11C 11D		
1E			4F				8F	9F		11E		
1F											12M	
1J	2M	3M	(1) <sup>4H</sup>	5M	6M	7M	8K	9J	10M	11H	-	
			4M							11L		
1M							8M	9M		SPACE		
			:-12A					Mod	C-12B			

# MCC 12A/12B ELEVATION

NOT TO SCALE





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#### KEYED NOTES:

- NEW CARBON ODOR CONTROL UNIT. REPLACE LABEL ON MCC BUCKET WITH NEW AS INDICATED ON THE MCC LOAD CALCULATION TABLE.
- RE-USE EXISTING SPARE BREAKER FOR BRANCH CIRCUIT FOR NEW CEM PANEL.
- FURNISH AND INSTALL NEW BRANCH CIRCUIT CONDUCTORS WHEN RE-LOCATING CONDENSER UNIT AND DISCONNECT. EXTEND EXISTING CONDUIT TO NEW DISCONNECT LOCATION.

Revision		By	Appd	Date
BID SET Issued		BB By	SM 1	NOVEMBER, 202 Date
File Name: 11697-E-601	FL Dwn.	BB Dsgn.	RC 1	NOVEMBER, 202 Date

Permit/Seal

BRADLEY C. BUCHANAN, PE

86225

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NORTH COUNTY WATER RECLAMATION FACILITY ODOR CONTROL - PHASE II

Title ELECTRICAL ELEVATION AND LOAD CALC MCC-12A/12B

Scale Project No. 177311697


**BID SET** 24 of 33 E-602

NO SCALE

Drawing No.

ORIGINAL SHEET - ANSI D

Phase

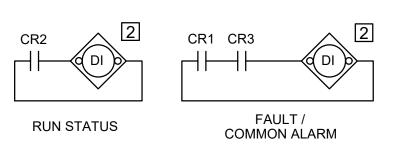

LOCATION LEGEND

1 FIELD
2 PLC

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#### NOTES

- A. THE STARTER SCHEMATIC IS DIAGRAMMATIC IN NATURE AND IS INTENDED ONLY TO CONVEY MINIMUM REQUIREMENTS AND OPERATING LOGIC. THE PANEL MANUFACTURER SHALL SUBMIT DETAIL SHOP DRAWINGS. THE STARTER CONTROL PANEL SHALL BE MANUFACTURED BY A UL 508A PANEL SHOP AND BEAR THE UL LABEL.
- THE SOFT STARTER SHALL BE HOUSED IN A NEMA 4X STAINLESS STEEL ENCLOSURE, PAINTED WHITE, WITH SUNSHIELDS. ALL PUSHBUTTONS, SWITCHES, PILOT LIGHTS, AND HMI SHALL BE PROTECTED FROM DIRECT SUN/WEATHER EXPOSURE.
- C. THE PANEL MANUFACTURER SHALL INCLUDE A COOLING SOLUTION AS NECESSARY TO MAINTAIN OPERATING TEMPERATURE WITHIN THE ENCLOSURE
- D. THE STARTER CIRCUIT BREAKER SHALL BE PAD LOCKABLE IN THE OFF POSITION.

Revision		Ву	Appd	Date
BID SET		 	SM	NOVEMBER, 202
Issued		Ву	Appd	Date
File Name: 11697-E-601	FL FL	BB	RC	NOVEMBER, 202
	Dwn.	Dsgn.	Chkd.	Date

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COLLIER COUNTY PUBLIC UTILITIES

NORTH COUNTY WATER RECLAMATION FACILITY ODOR CONTROL - PHASE II

Title
TYPICAL EXHAUST FAN
STARTER SCHEMATIC

Project No. Scale 177311697

**BID SET** 

Phase Drawing No.

E-603

NO SCALE

SOL TO THE PROPERTY OF THE PRO

ORIGINAL SHEET - ANSI D

25 of 33

THE FEEDER BREAKERS FOR THE EQ1 SCRUBBER AND THE CARBON ODOR CONTROL UNIT LCP-18200 ARE INTERLOCKED TO PREVENT SIMULTANEOUS OPERATION DUE TO POWER LIMITATIONS. THIS PROCEDURE DOCUMENTS HOW TO FEED POWER TO EACH EQUIPMENT.


### **PROCEDURES**

### **POWER EQ1 SCRUBBER**

- 1. SHUT DOWN AND VERIFY BOTH EQ1 SCRUBBER AND CARBON ODOR CONTROL UNIT LCP-18200 ARE SHUT DOWN, AND SWITCHES ARE IN OFF POSITION AT THEIR RESPECTIVE CONTROL PANELS.
- 2. OPEN THE CARBON ODOR CONTROL UNIT LCP-18200 FEEDER BREAKER (4H) AT MCC-12A, THEN ROTATE THE K3 KEY AT THE CARBON ODOR CONTROL UNIT LCP-18200 FEEDER BREAKER (4H) UNTIL KEY IS NO LONGER HELD CAPTIVE. REMOVE KEY.
- 3. INSERT KEY REMOVED IN PREVIOUS STEP INTO THE K3 LOCK AT THE EQ1 SCRUBBER FEEDER BREAKER (1C) IN MCC-12A AND ROTATE UNTIL FULLY ENGAGED AND IS HELD CAPTIVE, THEN CLOSE THE EQ1 SCRUBBER FEEDER BREAKER (1C).

### **POWER CARBON ODOR CONTROL UNIT LCP-18200**

- 1. SHUT DOWN AND VERIFY BOTH EQ1 SCRUBBER AND CARBON ODOR CONTROL UNIT LCP-18200 ARE SHUT DOWN, AND SWITCHES ARE IN OFF POSITION AT THEIR RESPECTIVE CONTROL PANELS.
- 2. OPEN THE EQ1 SCRUBBER FEEDER BREAKER (1C) AT MCC-12A, THEN ROTATE THE K3 KEY AT THE EQ1 SCRUBBER FEEDER BREAKER (1C) UNTIL KEY IS NO LONGER HELD CAPTIVE. REMOVE KEY.
- 3. INSERT KEY REMOVED IN PREVIOUS STEP INTO THE K3 LOCK AT THE CARBON ODOR CONTROL UNIT LCP-18200 FEEDER BREAKER (4H) IN MCC-12A AND ROTATE UNTIL FULLY ENGAGED AND IS HELD CAPTIVE, THEN CLOSE THE CARBON ODOR CONTROL UNIT LCP-18200 FEEDER BREAKER (4H).

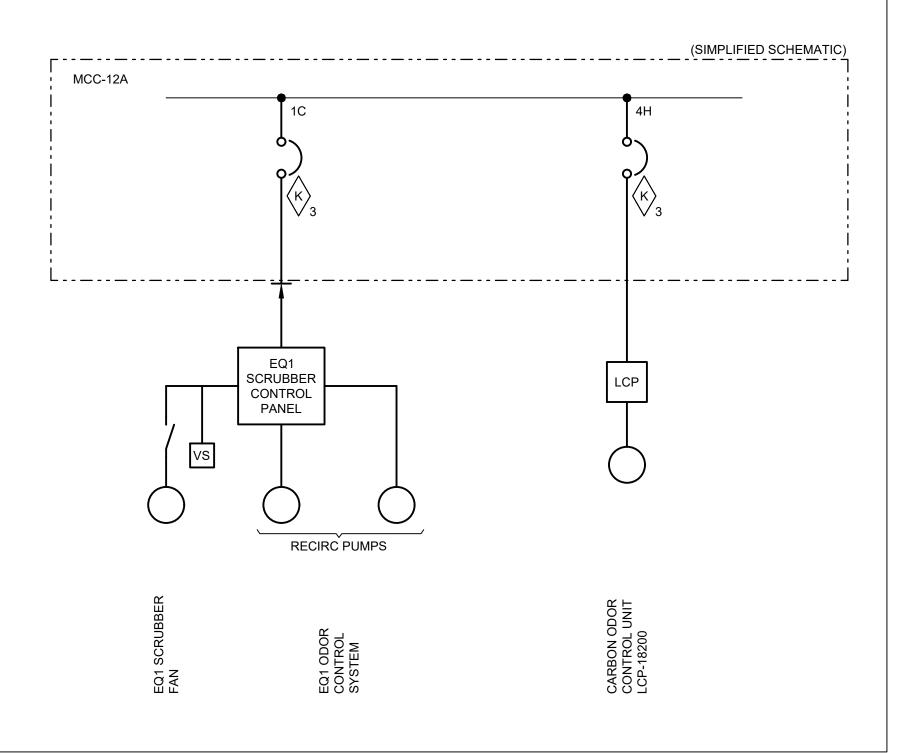

# **GENERAL INFORMATION**

THE FEEDER BREAKERS FOR THE EQ2 SCRUBBER AND THE CARBON ODOR CONTROL UNIT LCP-18100 ARE INTERLOCKED TO PREVENT SIMULTANEOUS OPERATION DUE TO POWER LIMITATIONS. THIS PROCEDURE DOCUMENTS HOW TO FEED POWER TO EACH EQUIPMENT.


# **PROCEDURES**

# **POWER EQ2 SCRUBBER**

- 1. SHUT DOWN AND VERIFY BOTH EQ2 SCRUBBER AND CARBON ODOR CONTROL UNIT LCP-18100 ARE SHUT DOWN, AND SWITCHES ARE IN OFF POSITION AT THEIR RESPECTIVE CONTROL PANELS.
- 2. OPEN THE CARBON ODOR CONTROL UNIT LCP-18100 FEEDER BREAKER (11B) AT MCC-12B, THEN ROTATE THE K4 KEY AT THE CARBON ODOR CONTROL UNIT LCP-18200 FEEDER BREAKER (11B) UNTIL KEY IS NO LONGER HELD CAPTIVE. REMOVE KEY.
- 3. INSERT KEY REMOVED IN PREVIOUS STEP INTO THE K4 LOCK AT THE EQ1 SCRUBBER FEEDER BREAKER (1C) IN MCC-12B AND ROTATE UNTIL FULLY ENGAGED AND IS HELD CAPTIVE, THEN CLOSE THE EQ1 SCRUBBER FEEDER BREAKER (11H).

# POWER CARBON ODOR CONTROL UNIT LCP-18100

- 1. SHUT DOWN AND VERIFY BOTH EQ2 SCRUBBER AND CARBON ODOR CONTROL UNIT LCP-18100 ARE SHUT DOWN, AND SWITCHES ARE IN OFF POSITION AT THEIR RESPECTIVE CONTROL PANELS.
- 2. OPEN THE EQ2 SCRUBBER FEEDER BREAKER (11H) AT MCC-12B, THEN ROTATE THE K4 KEY AT THE EQ2 SCRUBBER FEEDER BREAKER (11H) UNTIL KEY IS NO LONGER HELD CAPTIVE. REMOVE KEY.
- 3. INSERT KEY REMOVED IN PREVIOUS STEP INTO THE K4 LOCK AT THE CARBON ODOR CONTROL UNIT LCP-18100 FEEDER BREAKER (11B) IN MCC-12B AND ROTATE UNTIL FULLY ENGAGED AND IS HELD CAPTIVE, THEN CLOSE THE CARBON ODOR CONTROL UNIT LCP-18100 FEEDER BREAKER (11B).

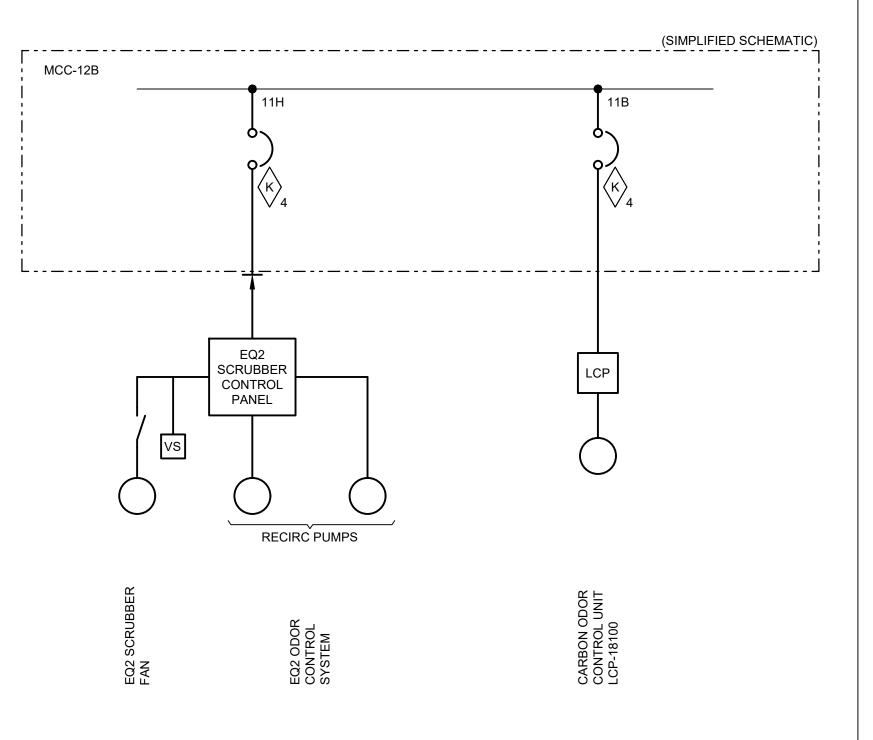




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NOTES

A. THE CONTRACTOR SHALL POST A LAMINATED COPY OF THE PROCEDURE FOR THE INTERLOCKS AT EACH MCC BUCKET WITH APPLICABLE KEYED INTERLOCK HARDWARE.



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Client/Project
COLLIER COUNTY PUBLIC UTILITIES

NORTH COUNTY WATER RECLAMATION FACILITY ODOR CONTROL - PHASE II

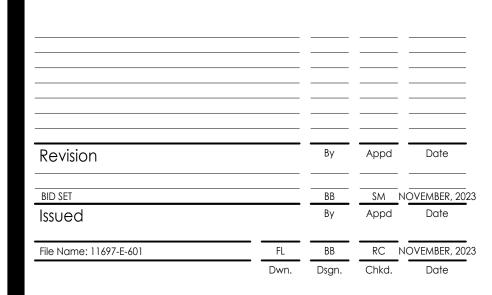Title
KEY INTERLOCK PROCEDURE

Project No. Scale 177311697

Phase

Drawing No.

BID SET 26 of 33

E-604

NO SCALE

### INSTRUMENT SYMBOLS

	CONTROL ROOM PANEL	FIELD MOUNTED	LOCAL PANEL
DISCRETE INSTRUMENTS	SD		
SHARED DISPLAY SHARED  CONTROL eg. DCS =  DISTRIBUTED CONTROL  SYSTEM			
COMPUTER FUNCTION eg. FLOW METER			
PROGRAMMABLE LOGIC CONTROL (PLC) (RTU)			

\*SUBSCRIPT ABBREVIATION SPECIFIES INSTRUMENT FUNCTION OR LOCATION. eg. IP#1 (INSTRUMENT PANEL #1), SD (SHUTDOWN)

FIELD MOUNTED INSTRUMENTS MAY BE POST OR WALL MOUNTED

STATUS LIGHT SHOW COLOUR INSIDE SYMBOL

SYSTEM LOGIC

R
MANUAL RESET

E EMERGENCY SHUTDOWN LOGIC

P PURGE OR FLUSHING DEVICE

ORIFICE PLATE C/W ORIFICE FLANGES

FLOW INDICATOR ROTAMETER TYPE

TURBINE OR PROPELLER TYPE PRIMARY ELEMENT

ANNUBAR OR PITOT TUBE

MAGNETIC FLOW METER

VORTEX FLOW METER

ULTRASONIC FLOW METER

VCP LOCAL CONTROL PANEL INDLUDED IN VENDOR PACKAGE

ACP AREA CONTROL PANEL

DIGITAL INPUT

DIGITAL OUTPUT

ANALOG INPUT

PULSE INPUT

ANALOG OUTPUT

MODULATING DIGITAL OUTPUT

**INSTRUMENT LINE SYMBOLS** 

ELECTRICAL SIGNAL

CONTROL SYSTEM DATA LINK DEVICENET OR ETHERNET AS NOTED

DATA LINK OR SYSTEM BUS AND SOFT INTERAL LINK

ELECTROMAGNETIC OR SONIC SIGNAL (GUIDED AND NON GUIDED)

INTERLOCK

FO FO FO FIBER OPTIC

WIRELESS

NOTES:

1. FINAL INTERCONNECTION IS SUBJECT TO PRE-PACKAGED PROCESS EQUIPMENT VENDOR. CONTRACTOR TO PROVIDE ALL POWER, CONTROLS AND SIGNALS REQUIRED TO MEET THE REQUIREMENTS.

2. PANEL MOUNTED EQUIPMENT SHOWN FOR FUTURE FIELD DEVICES SHALL BE PROVIDED.

# RELAY FUNCTION DESIGNATORS

≥	ADD	>	HIGH SELECT
	SUBTRACT	<	LOW SELECT
±	BIAS	$\square_{A/D}$	ANALOG TO DIGITAL
%	GAIN OR ATTENUATE	REV	REVERSE
<b>7</b>	EXTRACT SQ ROOT	E/P	POTENTIAL TO PNEUMATIC
<b>=</b>	DIVIDE	I/P	CURRENT TO PNEUMATIC
X	MULTIPLY	E/I	POTENTIAL TO CURRENT
1:1	BOOST		

# IDENTIFICATION LETTERS

	FIRST-LET	ΓΤER	SUCCEEDING-LETTERS			
	MEASURED OR INITIATING VARIABLE	MODIFIER	READOUT OR PASSIVE FUNCTION	OUTPUT FUNCTION	MODIFIER	
Α	ANALYSIS		ALARM			
В	BURNER, COMBUSTION					
С	CIRCUIT			CONTROL	CLOSED	
D	DISCONNECT	DIFFERENTIAL				
Е	VOLTAGE / EMERGENCY		SENSOR (PRIMARY ELEMENT)			
F	FLOW RATE	RATIO (FRACTION)				
G	GENERAL / COMMENT		GLASS, VIEWING DEVICE	GAUGE		
Н	HAND OPERATED				HIGH	
I	CURRENT (ELECTRICAL)		INDICATE			
J	POWER	SCAN				
К	TIME, TIME SCHEDULE	TIME RATE OF CHANGE		CONTROL STATION		
L	LEVEL		LIGHT (PILOT)		LOW	
М	MOTOR	MOMENTARY			MIDDLE, INTERMEDIATE	
N	MOISTURE		ON STATUS			
0	ON / OFF		ORIFICE, RESTRICTION		OPEN	
Р	PRESSURE, VACUUM		POINT (TEST) CONNECTION			
Q	QUANTITY	INTEGRATE, TOTALIZE				
R	RADIATION		RECORD			
S	SPEED, FREQUENCY	SAFETY		SWITCH		
Т	TEMPERATURE			TRANSMIT		
U	MULTIVARIABLE		MULTIFUNCTION	MULTIFUNCTION	MULTIFUNCTION	
V	VIBRATION, MECHANICAL ANALYSIS			VALVE, DAMPER, LOUVER		
W	WEIGHT, FORCE, TORQUE		WELL			
Х	INTRUSION	X AXIS				
Υ	EVENT OR PRESENCE	Y AXIS		RELAY, COMPUTE, CONVERT		
Z	POSITION, DIMENSION	Z AXIS		DRIVER, ACTUATOR, UNCLASSIFIED FINAL CONTROL ELEMENT		

# CLARIFYING ABBREVIATION

CURRENT TO PNEUMATIC

LOCAL CONTROL PANEL LOWER EXPLOSIVE LIMIT

LOCAL/OFF/REMOTE


LEL

<b>ABBREVIATION</b>	DESCRIPTION	<b>ABBREVIATION</b>	DESCRIPTION
ABBREVIATION  ACK ACP AIRT A/S BRG CL2 CG COMB CT IFF DISCH DO DP DPIT DSP ESO	ACKNOWLEDGE AREA CONTROL PANEL ANALYZE INDICATE RECORDER TRANSMITTER AIR SUPPLY BEARING CHLORINE, SODIUM HYPOCHLORITE COMBUSTIBLE GAS COMBUSTIBLE GAS CURRENT TRANSFORMER DIFFERENTIAL DISCHARGE DISSOLVED OXYGEN DIFFERENTIAL PRESSURE DIFFERENCTIAL PRESSURE DISPLAY EMERGENCY SHUTDOWN	ABBREVIATION  CEM LRSS M/A NH2CL NH4 O2 OBD OC OL OO ORP P PAR PLC RS RIO	DESCRIPTION  CONTINUOUS EMISSION MONITORS LOW RANGE SAMPLING SYSTEM MANUAL/AUTO MONOCHLORAMINE AMMONIUM SULFATE OXYGEN OUTBOARD OPEN/CLOSE OVERLOAD ON/OFF OXYGEN REDUCTION POTENTIAL PUMP PROCESS ALARM RELAY PROGRAMMABLE LOGIC CONTROL RESET REMOTE INPUT/OUTPUT
ETM	ELAPSED TIME METER	SP	SET POINT
FC 50	FAIL CLOSED	SW	SELECTOR SWITCH
FO H HH	FAIL OPEN HIGH HIGH-HIGH	SS TMR TURB	STOP/START TIMER TURBIDITY
НМІ	HUMAN MACHINE INTERFACE	UPS	UNINTERRUPTABLE POWER SUPPLY
HOA HORN	HAND/OFF/AUTO	VCP VIB	VENDOR CONTROL PANEL VIBRATION
HORN HOR H2S	ANNUNCIATOR HORN HAND/OFF/REMOTE HYDROGEN SULPHIDE	WDG	WINDING
IBD I/I	INBOARD CURRENT/CURRENT ISOLATION		


# HAND SWITCH DESIGNATION

ES - EMERGENCY STOP
FOR - FORWARD-OFF-REVERSE
HOA - HAND-OFF-AUTO
HOR - HAND-OFF-REMOTE
J - JOG
LOR - LOCAL-OFF-REMOTE
LR - LOCAL-REMOTE
OC - OPEN-CLOSE
OO - ON-OFF
RS - RESET
ST - START
SP - STOP
TMR - TIMER

# **EQUIPMENT IDENTIFICATION TAG**

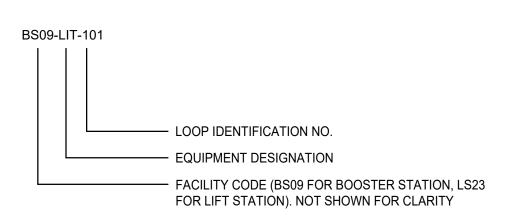

# **INSTRUMENT TAG NUMBERS & INDENTIFICATION**

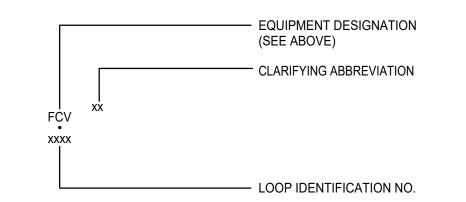



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NOTES

 Revision
 By
 Appd
 Date

 BID SET
 BB
 SM
 NOVEMBER, 2023

 Issued
 By
 Appd
 Date

 File Name: 11697-I-001
 FL
 BB
 RC
 NOVEMBER, 2023

Permit/Seal

BRADLEY C. BUCHANAN, PE 86225

Client/Project
COLLIER COUNTY PUBLIC UTILITIES

NORTH COUNTY WATER RECLAMATION FACILITY ODOR CONTROL - PHASE II

Title
INSTRUMENTATION AND CONTROLS
GENERAL NOTES, LEGENDS,
AND ABBREVIATIONS

Project No.
177311697

Phase

Scale


NO SCALE

Drawing No.

BID SET 27 of 33

I-001

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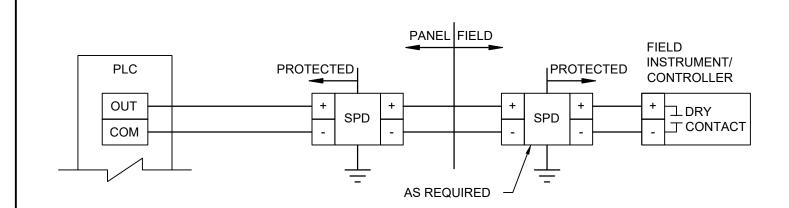
SPD, LOCAL DISCONNECT, AND 120V BRANCH

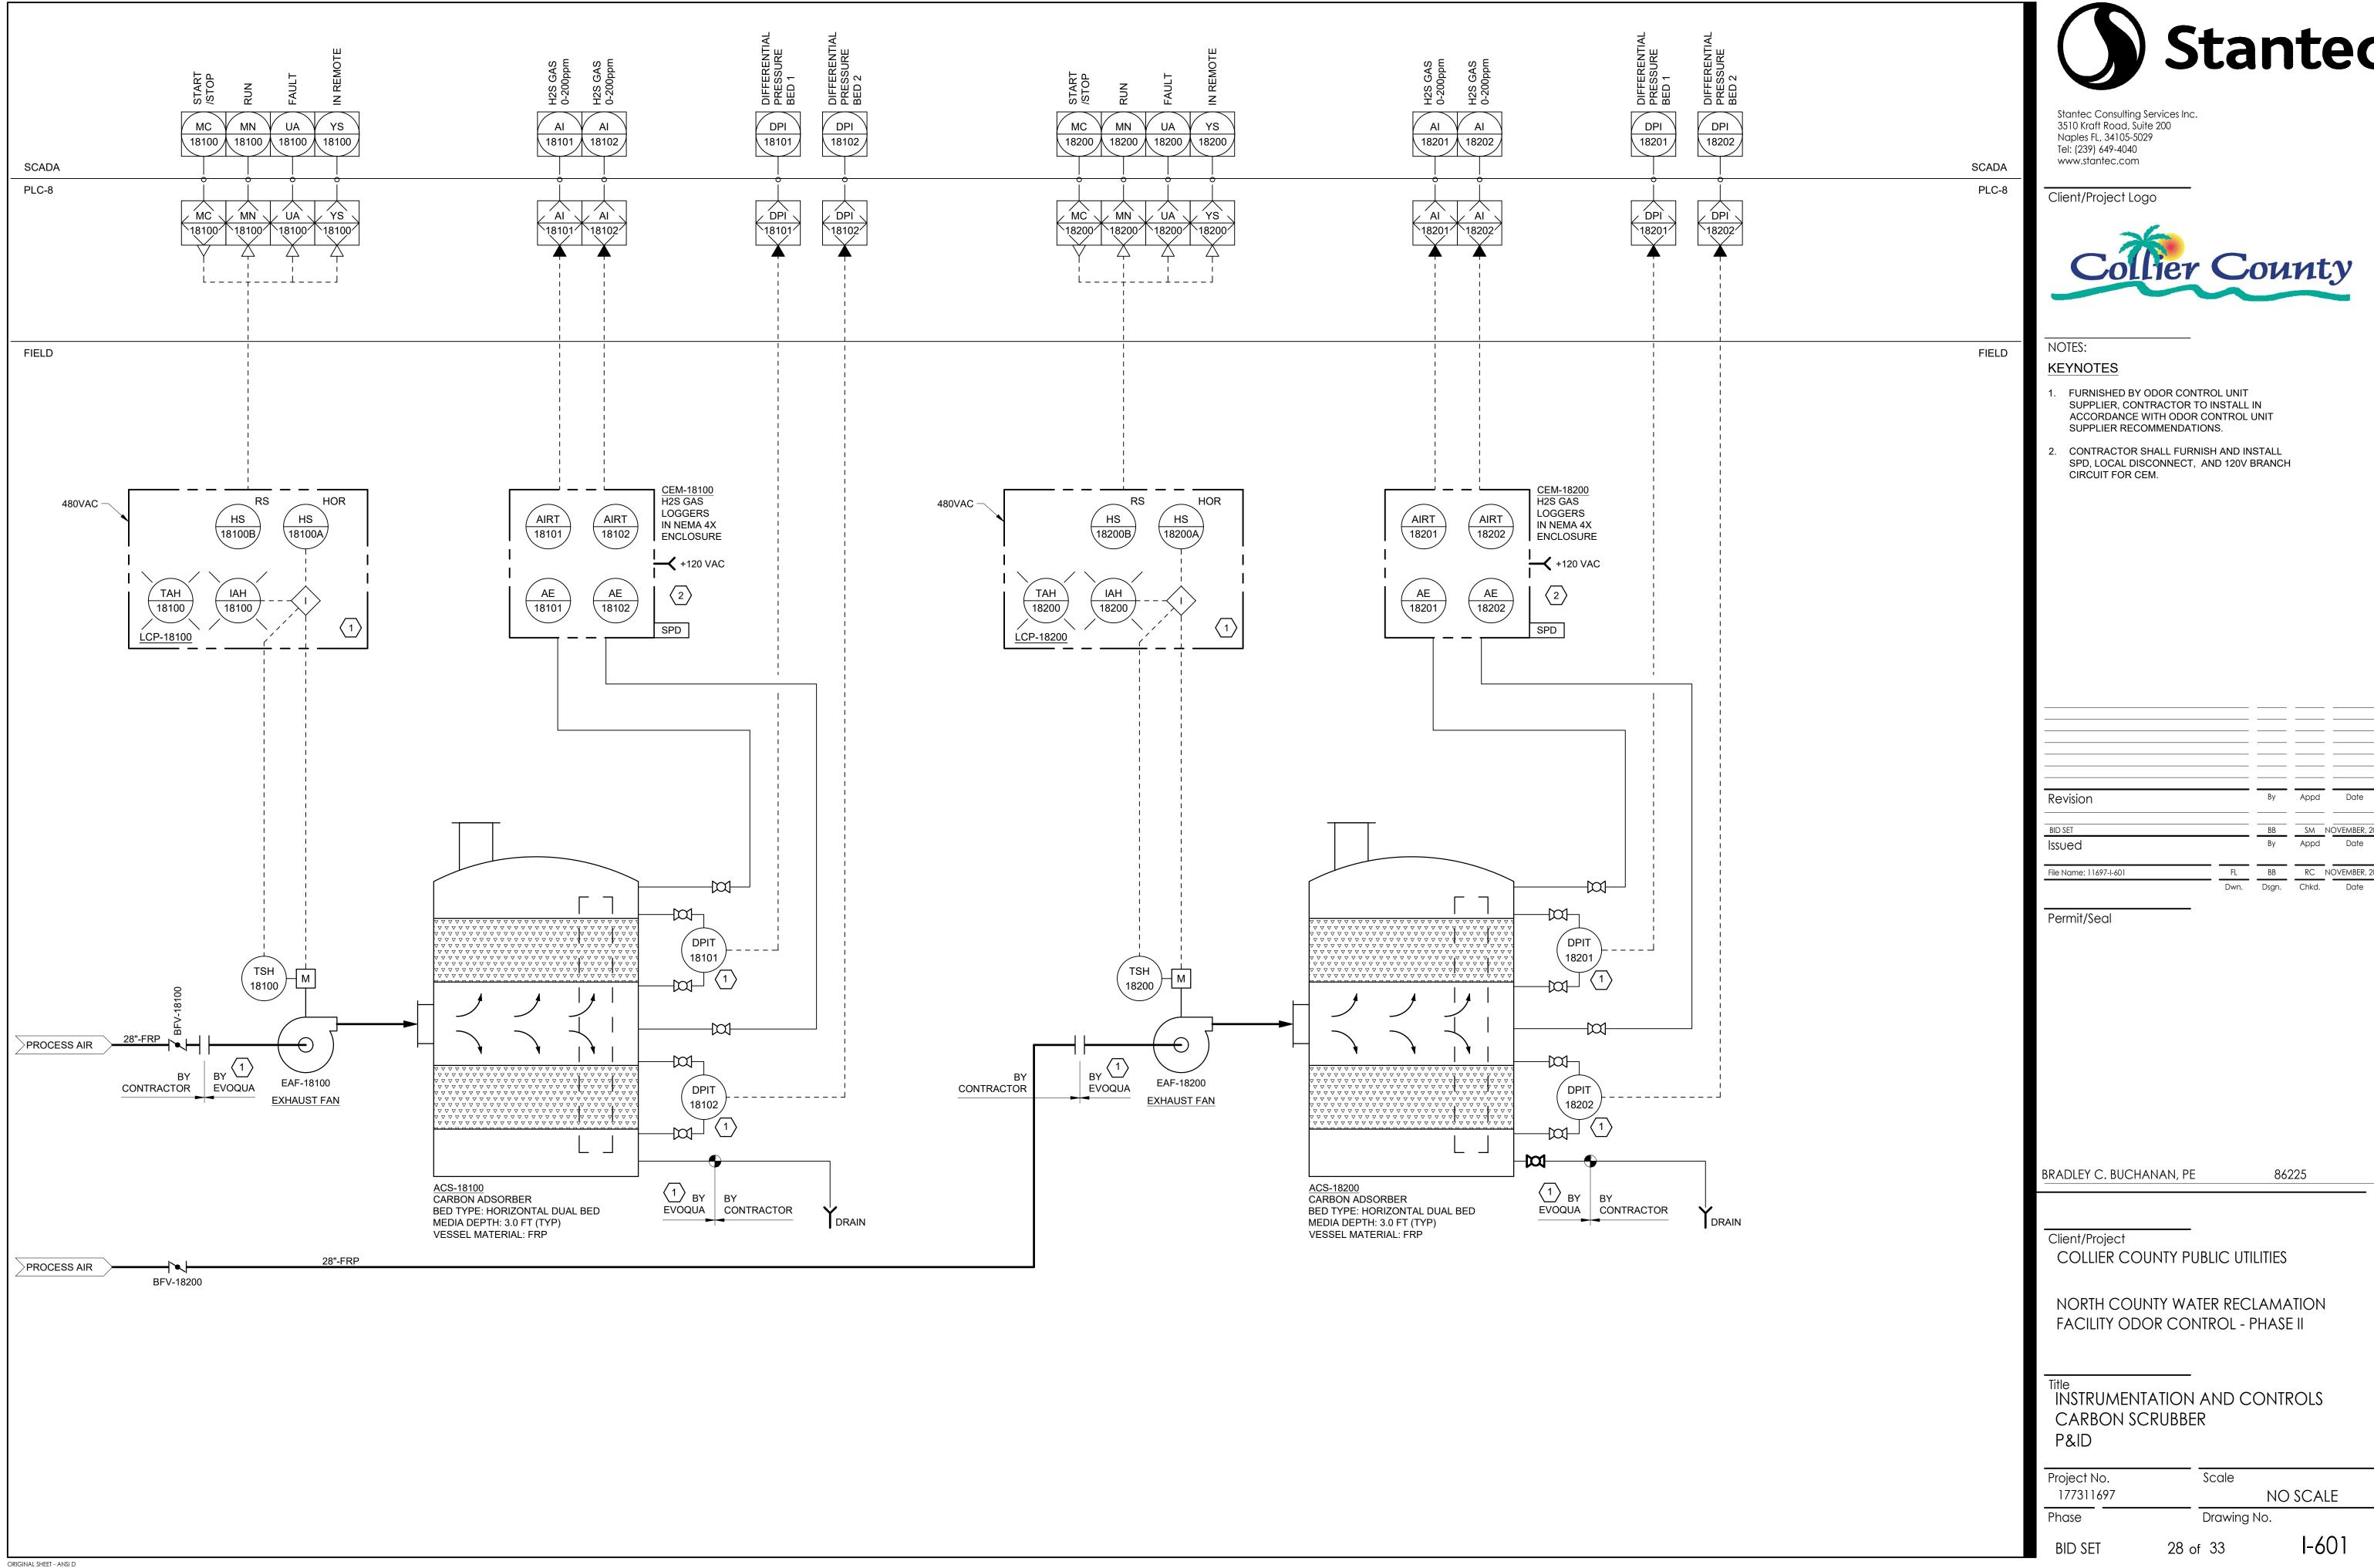Revision		Ву	Appd	Date
BID SET		BB	SM N	OVEMBER, 202
Issued		Ву	Appd	Date
File Name: 11697-I-601	FL	ВВ	RC N	OVEMBER, 202

FACILITY ODOR CONTROL - PHASE II


INSTRUMENTATION AND CONTROLS

I-601



- 1. TERMINATE SPD DIRECTLY TO GROUND BUS, DO NOT DAISY CHAIN.
- 2. WHERE SPD ARE REQUIRED IN THE FIELD, INSTALL SURGE PROTECTION AS CLOSE TO FIELD DEVICE AS POSSIBLE.




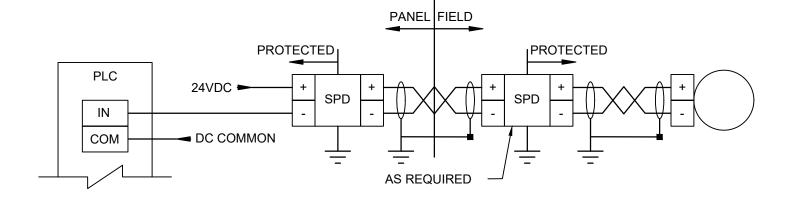

### NOTES:

- 1. TERMINATE SPD DIRECTLY TO GROUND BUS. DO NOT DAISY CHAIN.
- 2. TERMINATE SHIELD/ DRAIN WIRE DIRECTLY TO SHIELD BUS/ GROUND. DO NOT DAISY CHAIN.
- 3. TAPE BACK SHIELD/ DRAIN WIRE WHERE INDICATED.
- 4. WHERE SPD ARE REQUIRED IN THE FIELD, INSTALL SURGE PROTECTION AS CLOSE TO FIELD DEVICE AS POSSIBLE.


TYPICAL TRANSMITTER LOOP (LOOP POWERED: 2 WIRE) Scale: NO SCALE

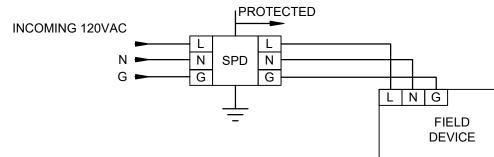


### NOTES:


- 1. TERMINATE SPD DIRECTLY TO GROUND BUS. DO NOT DAISY CHAIN.
- 2. WHERE SPD ARE REQUIRED IN THE FIELD, INSTALL SURGE PROTECTION AS CLOSE TO FIELD DEVICE AS POSSIBLE.

TYPICAL FIELD INSTRUMENT 120V SOURCE SURGE PROTECTION Scale: NO SCALE

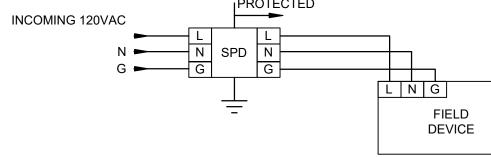

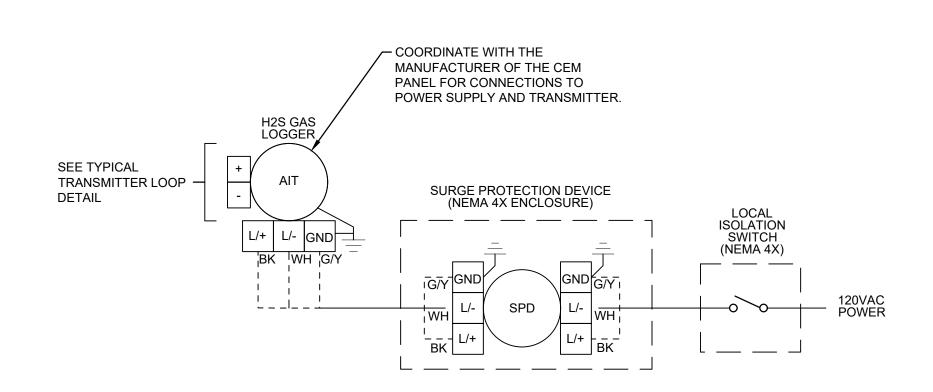

TYPICAL CEM PANEL 120V SOURCE SURGE PROTECTION Scale: NO SCALE

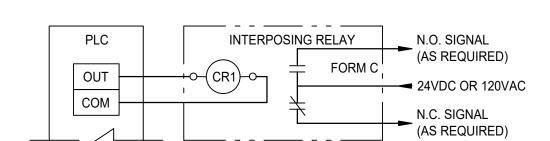

TYPICAL DISCRETE OUTPUT LOOP Scale: N.T.S.



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THE CONTRACTOR SHALL FURNISH AND INSTALL SURGE PROTECTION DEVICES (SPD) IN THE PLC CABINET AND THE INSTRUMENT.

Revision Appd Date Issued File Name: 11697-I-601

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BRADLEY C. BUCHANAN, PE

Client/Project COLLIER COUNTY PUBLIC UTILITIES

NORTH COUNTY WATER RECLAMATION FACILITY ODOR CONTROL - PHASE II

**INSTRUMENTATION AND CONTROLS** TYPICAL LOOP DIAGRAMS

Scale Project No. NO SCALE 177311697 Phase Drawing No.

29 of 33 **BID SET** 

86225

ORIGINAL SHEET - ANSI D

I-602

# **GENERAL NOTES**

- A. THE MODIFICATIONS SHOWN HEREIN ARE GENERAL IN NATURE. THE CONTRACTOR SHALL FURNISH AND INSTALL ALL WIRING, SPDs, TERMINALS, ETC. REQUIRED FOR CONNECTION OF THE NEW INSTRUMENTATION. WHERE PART NUMBERS ARE INDICATED, THEY SHALL BE AS INDICATED OR EQUIVALENT.
- B. ALL NEW TERMINALS AND WIRES SHALL HAVE UNIQUE TERMINAL AND WIRE NUMBERS, FOLLOWING THE FORMAT OF THE NUMBERING WITHIN THE PANEL.
- C. THE CONTRACTOR SHALL FURNISH AS-BUILT DRAWINGS IN ELECTRONIC FORMAT WITH SCHEMATIC UPDATES FOR ALL CHANGES MADE INSIDE THE CONTROL PANEL, AS WELL AS LAMINATED 8.5"x11" SHEETS TO REPLACE THE REVISED AS-BUILT DRAWING SCHEMATICS INSIDE THE PANEL.

# SHEET KEYNOTES

ELLIE ELLIE ELLIE

111111111

- FURNISH AND INSTALL NEW "SPD 10" DITEK DTK-4LVLPLV OR EQUAL.
- 2. FURNISH AND INSTALL TERMINALS FOR DISCRETE I/O FIELD CONNECTIONS. SPACE MAY ALSO BE USED FOR SPD IF SUFFICIENT SPACE IS NOT AVAILABLE AT THE LOCATIONS INDICATED (SEE KEYNOTE 1).
- 3. FURNISH AND INSTALL NEW SPDs FOR ANALOG SIGNALS. FOR DIN-RAIL MOUNTED SPDs, FURNISH AND INSTALL APPROPRIATE LENGTH OF DIN-RAIL.
- 4. FURNISH AND INSTALL TERMINALS FOR ANALOG I/O FIELD CONNECTIONS. SPACE MAY ALSO BE USED FOR SPDs IF SUFFICIENT SPACE IS NOT AVAILABLE AT THE LOCATIONS INDICATED (SEE KEYNOTE 3).
- 5. FURNISH AND INSTALL INTRINSIC SAVE ISOLATORS. PROVIDE PHYSICAL SEPARATION OF AT LEAST 2 INCHES OR METAL PARTITION BETWEEN INTRINSICALLY SAFE AND NON-INTRINSICALLY SAFE CIRCUIT CONDUCTORS IN ACCORDANCE WITH NEC.



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	Ву	Appd	Date
	BB	SM N	OVEMBER, 2023
	Ву	Appd	Date
FL FL	ВВ	RC N	IOVEMBER, 2023
Dwn.	Dsgn.	Chkd.	Date
		BB By FL BB	BB SM N By Appd  FL BB RC N

BRADLEY C. BUCHANAN, PE

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NORTH COUNTY WATER RECLAMATION FACILITY ODOR CONTROL - PHASE II

PLC-8 MODIFICATIONS LAYOUT


Scale Project No. NO SCALE 177311697 Drawing No. Phase

30 of 33 **BID SET** 

I-701

ORIGINAL SHEET - ANSI D

WINTER.

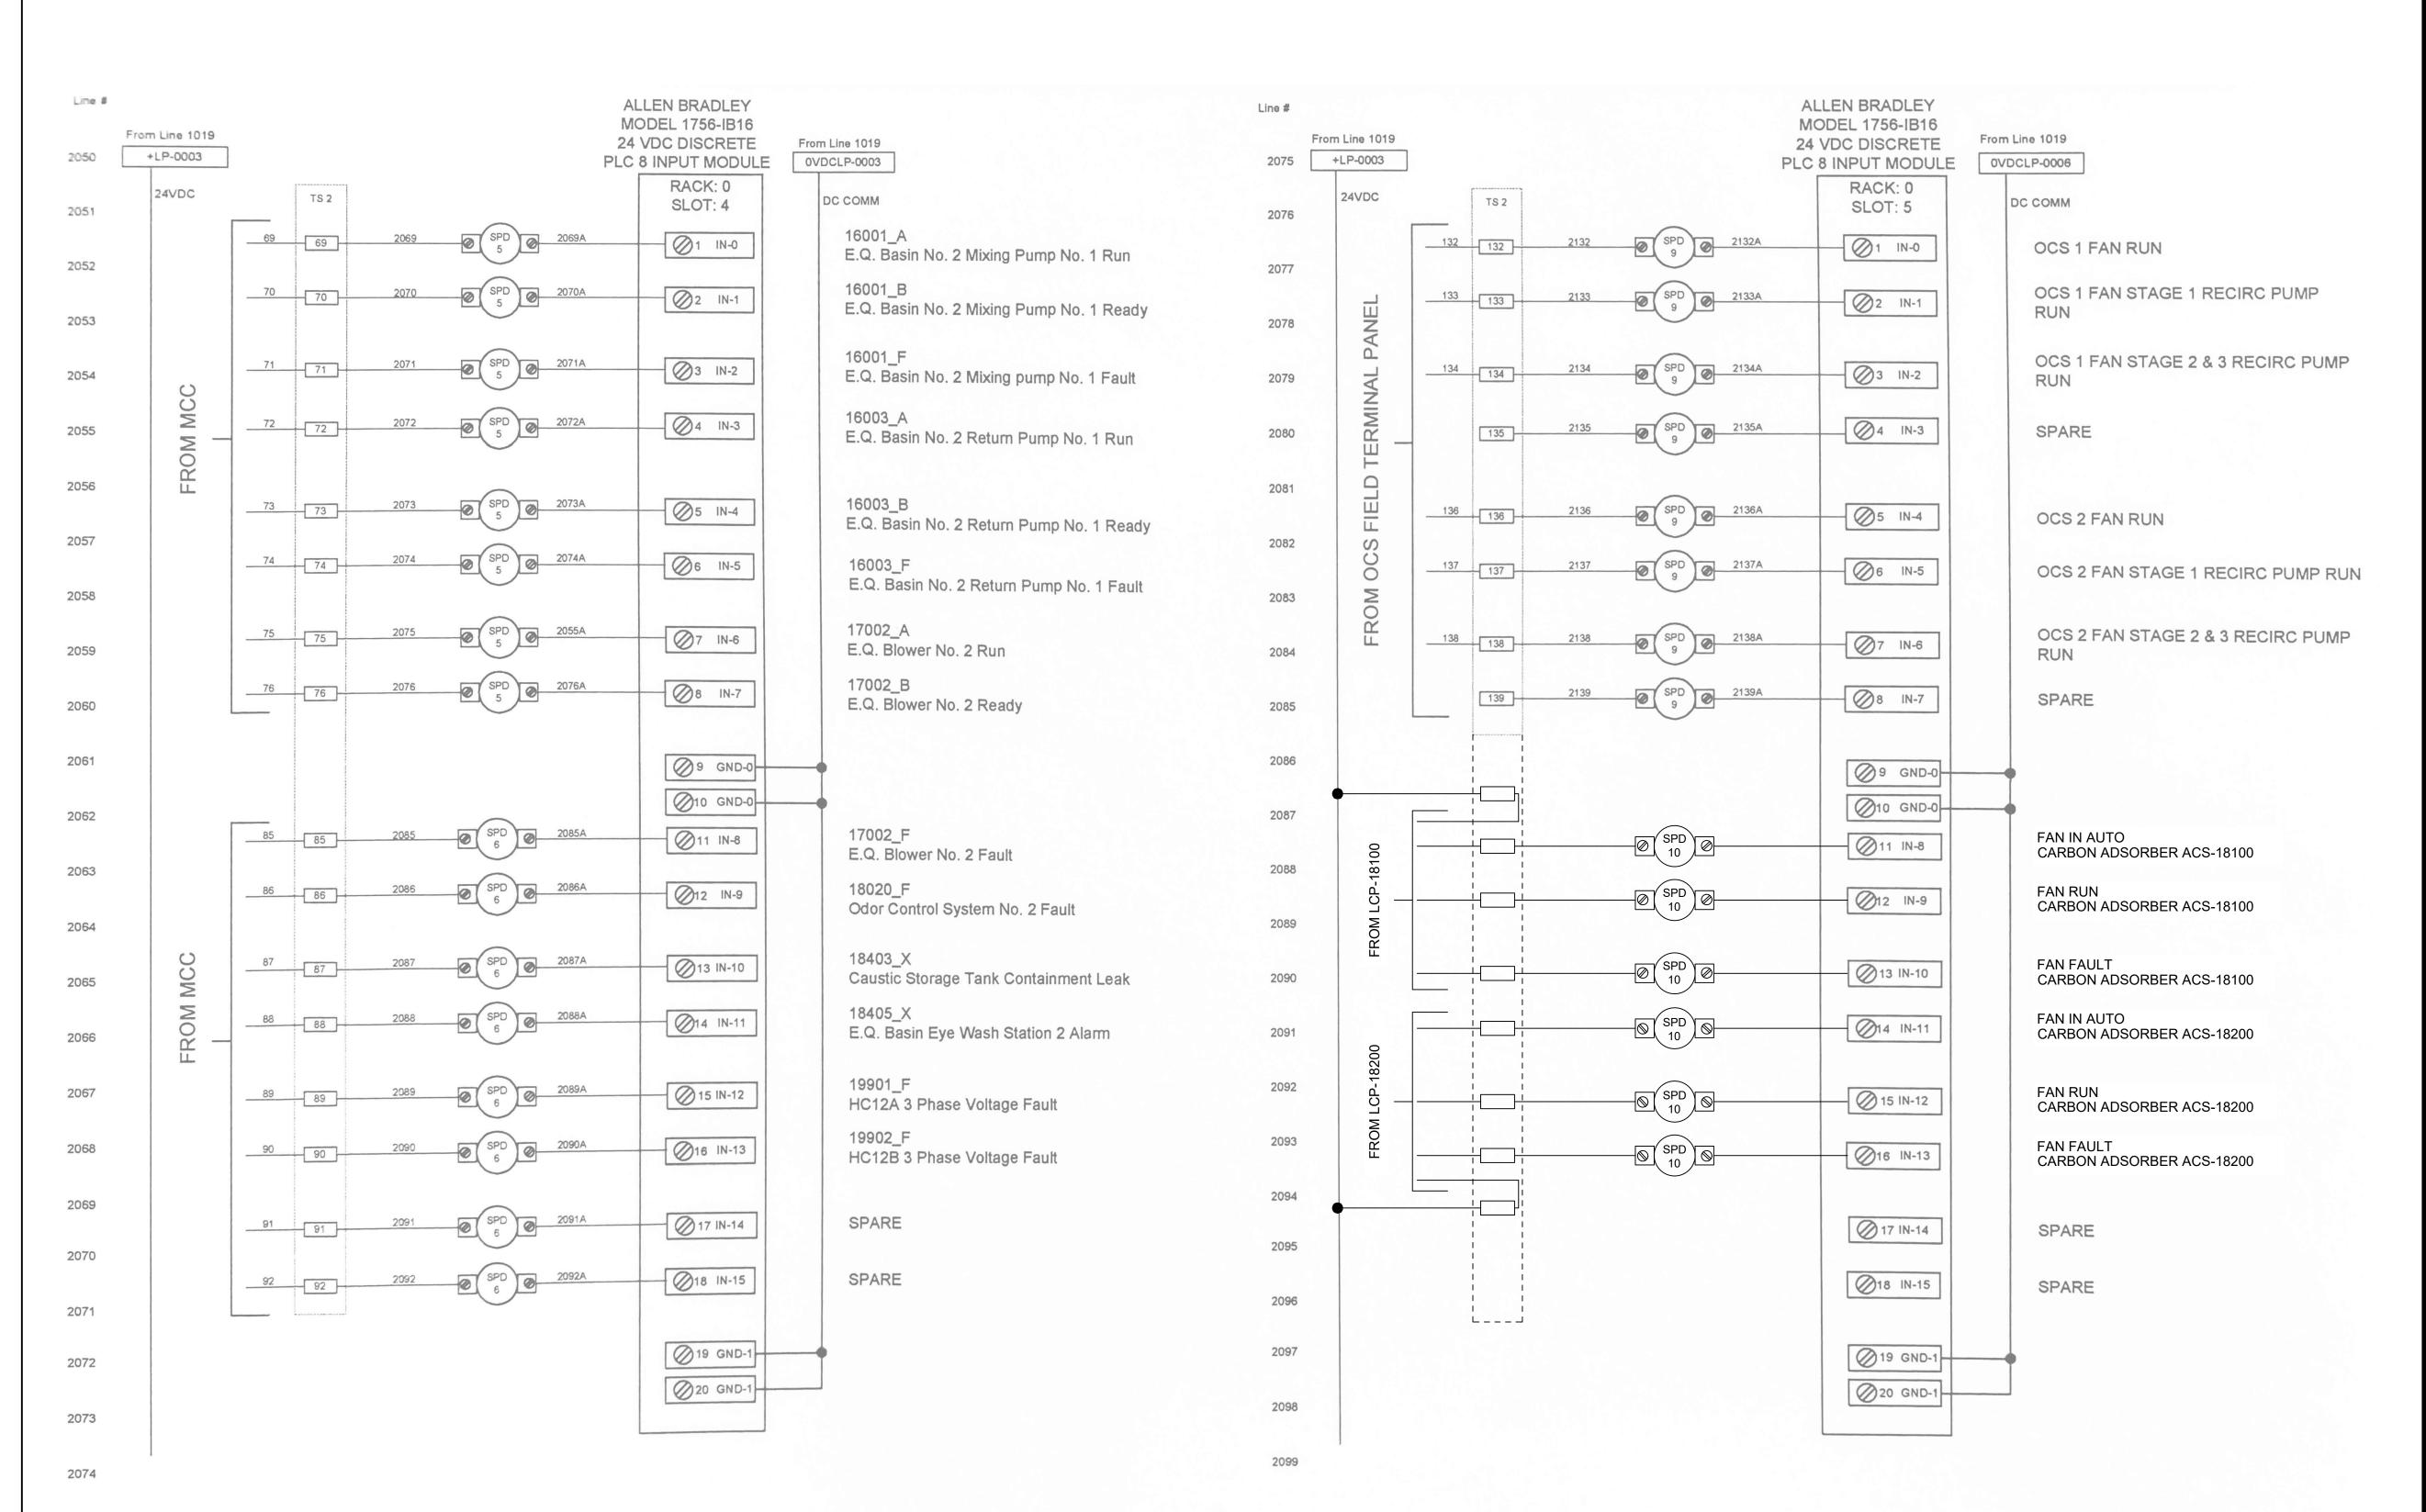



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Client/Project Logo



NOTI

1. THE INTEGRATOR SHALL SUBMIT SHOP DRAWINGS WITH UNIQUE WIRE AND TERMINAL NUMBERS CONSISTENT WITH THE EXISTING PANEL'S NUMBERING SCHEME. THE CONTRACTOR SHALL FURNISH AND INSTALL LABELS WITH THE WIRE AND TERMINAL NUMBERS PROVIDED IN THE SHOP DRAWING SUBMITTAL.

Revision		Ву	Appd	Date
DID CET				
BID SET		ВВ	<u>2W</u> N	OVEMBER, 2023
Issued		Ву	Appd	Date
File Name: 11697-I-701	FL	ВВ	RC N	OVEMBER, 2023

Permit/Seal

BRADLEY C. BUCHANAN, PE

PE 86225

Client/Project
COLLIER COUNTY PUBLIC UTILITIES

NORTH COUNTY WATER RECLAMATION FACILITY ODOR CONTROL - PHASE II

PLC-8 MODIFICATIONS SCHEMATIC - I

Project No. Scale 177311697

Phase


NO SCALE

Drawing No.

BID SET 31 of 33

I-702

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Revision		Ву	Appd	Date
BID SET		ВВ	SM	NOVEMBER, 2023
Issued		Ву	Appd	Date
File Name: 11697-I-701	FL	ВВ	RC	NOVEMBER, 2023

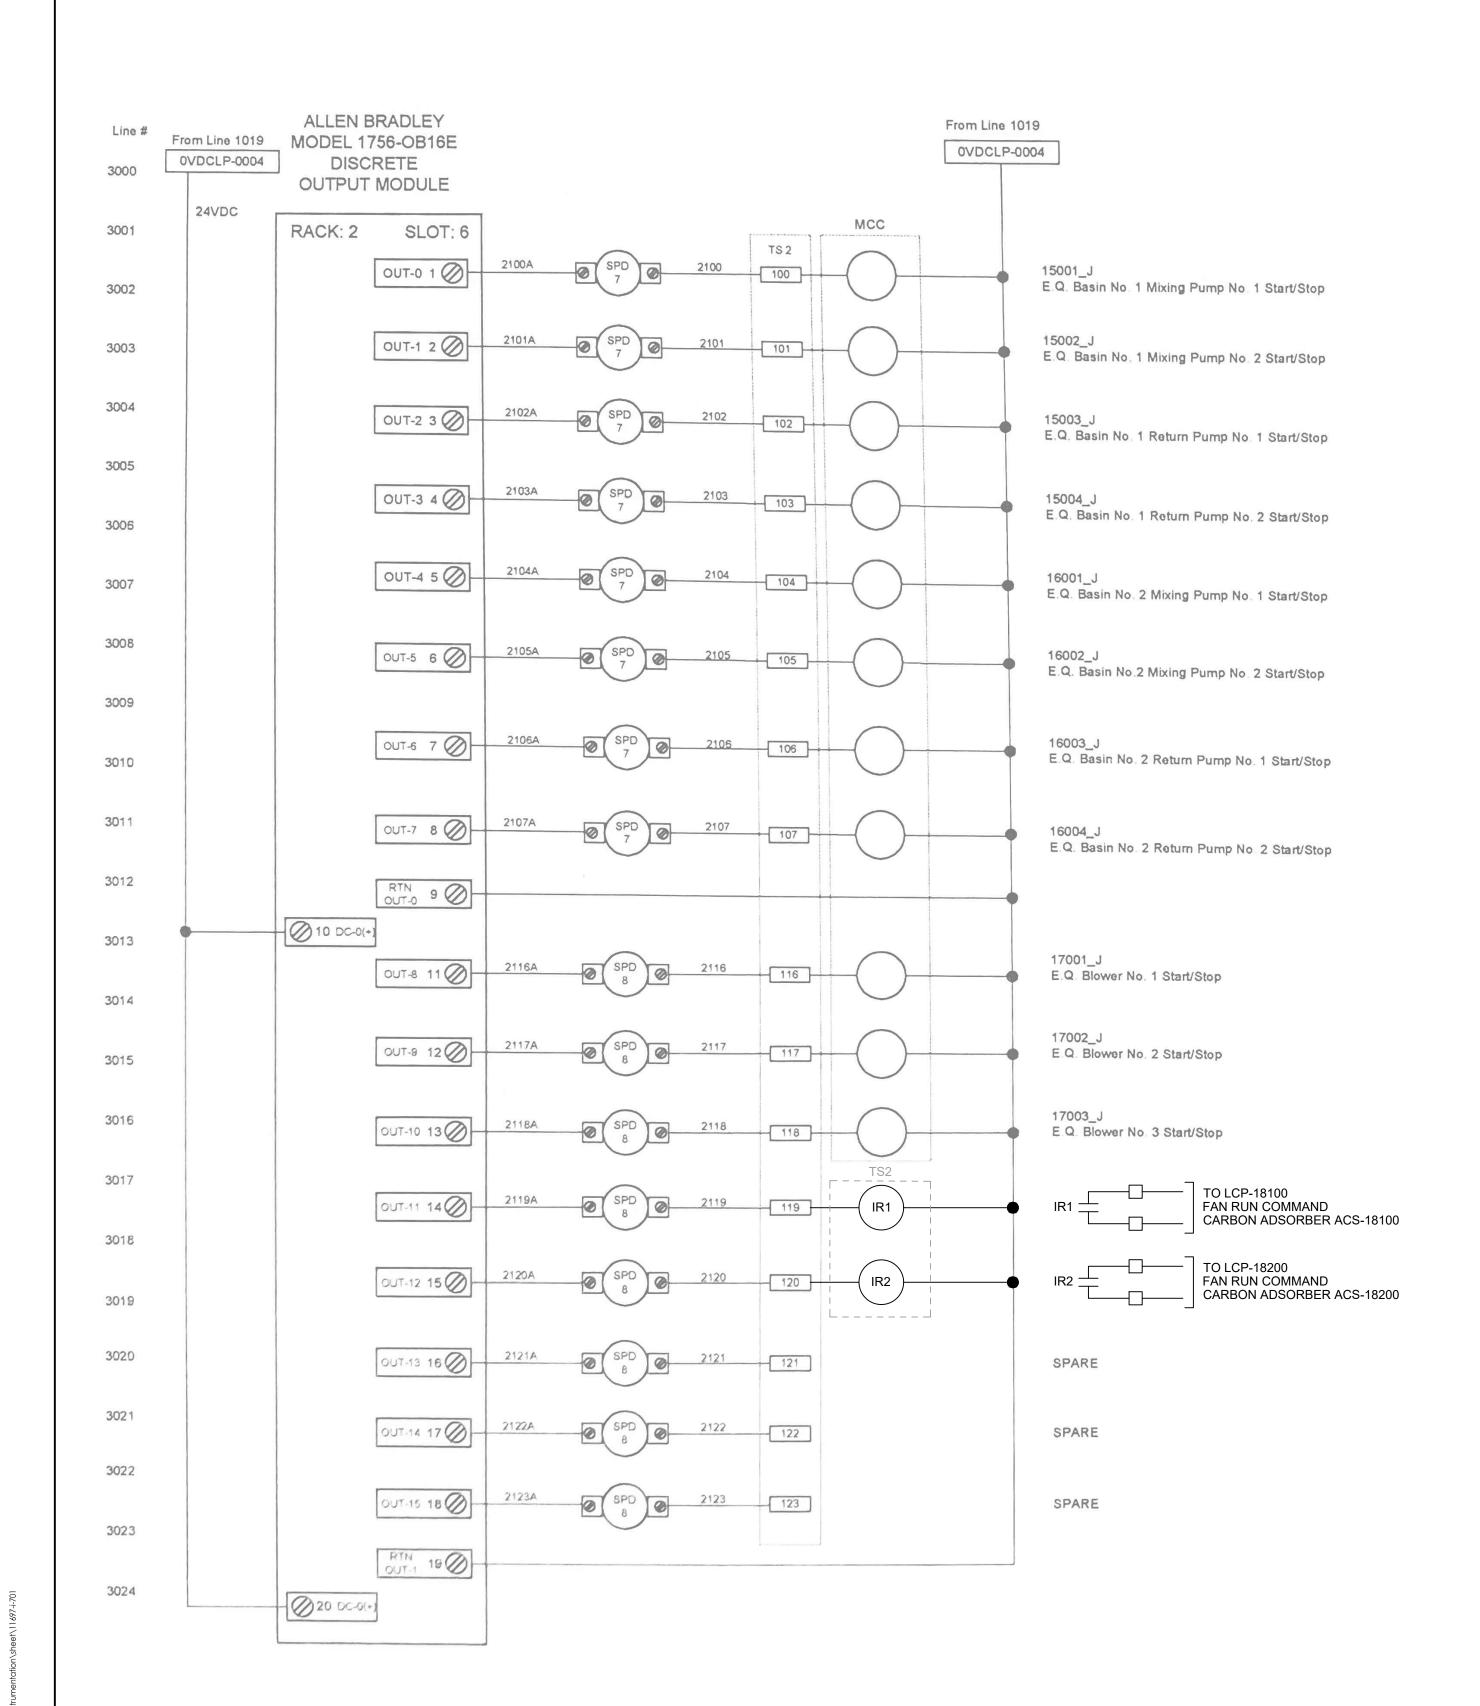Permit/Seal

BRADLEY C. BUCHANAN, PE

86225

Client/Project
COLLIER COUNTY PUBLIC UTILITIES

NORTH COUNTY WATER RECLAMATION FACILITY ODOR CONTROL - PHASE II


PLC-8 MODIFICATIONS SCHEMATICS - II

Project No.
Scale
NO SCALE
Phase Drawing No.

BID SET 32 of 33

I-703

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BRADLEY C. BUCHANAN, PE 86225

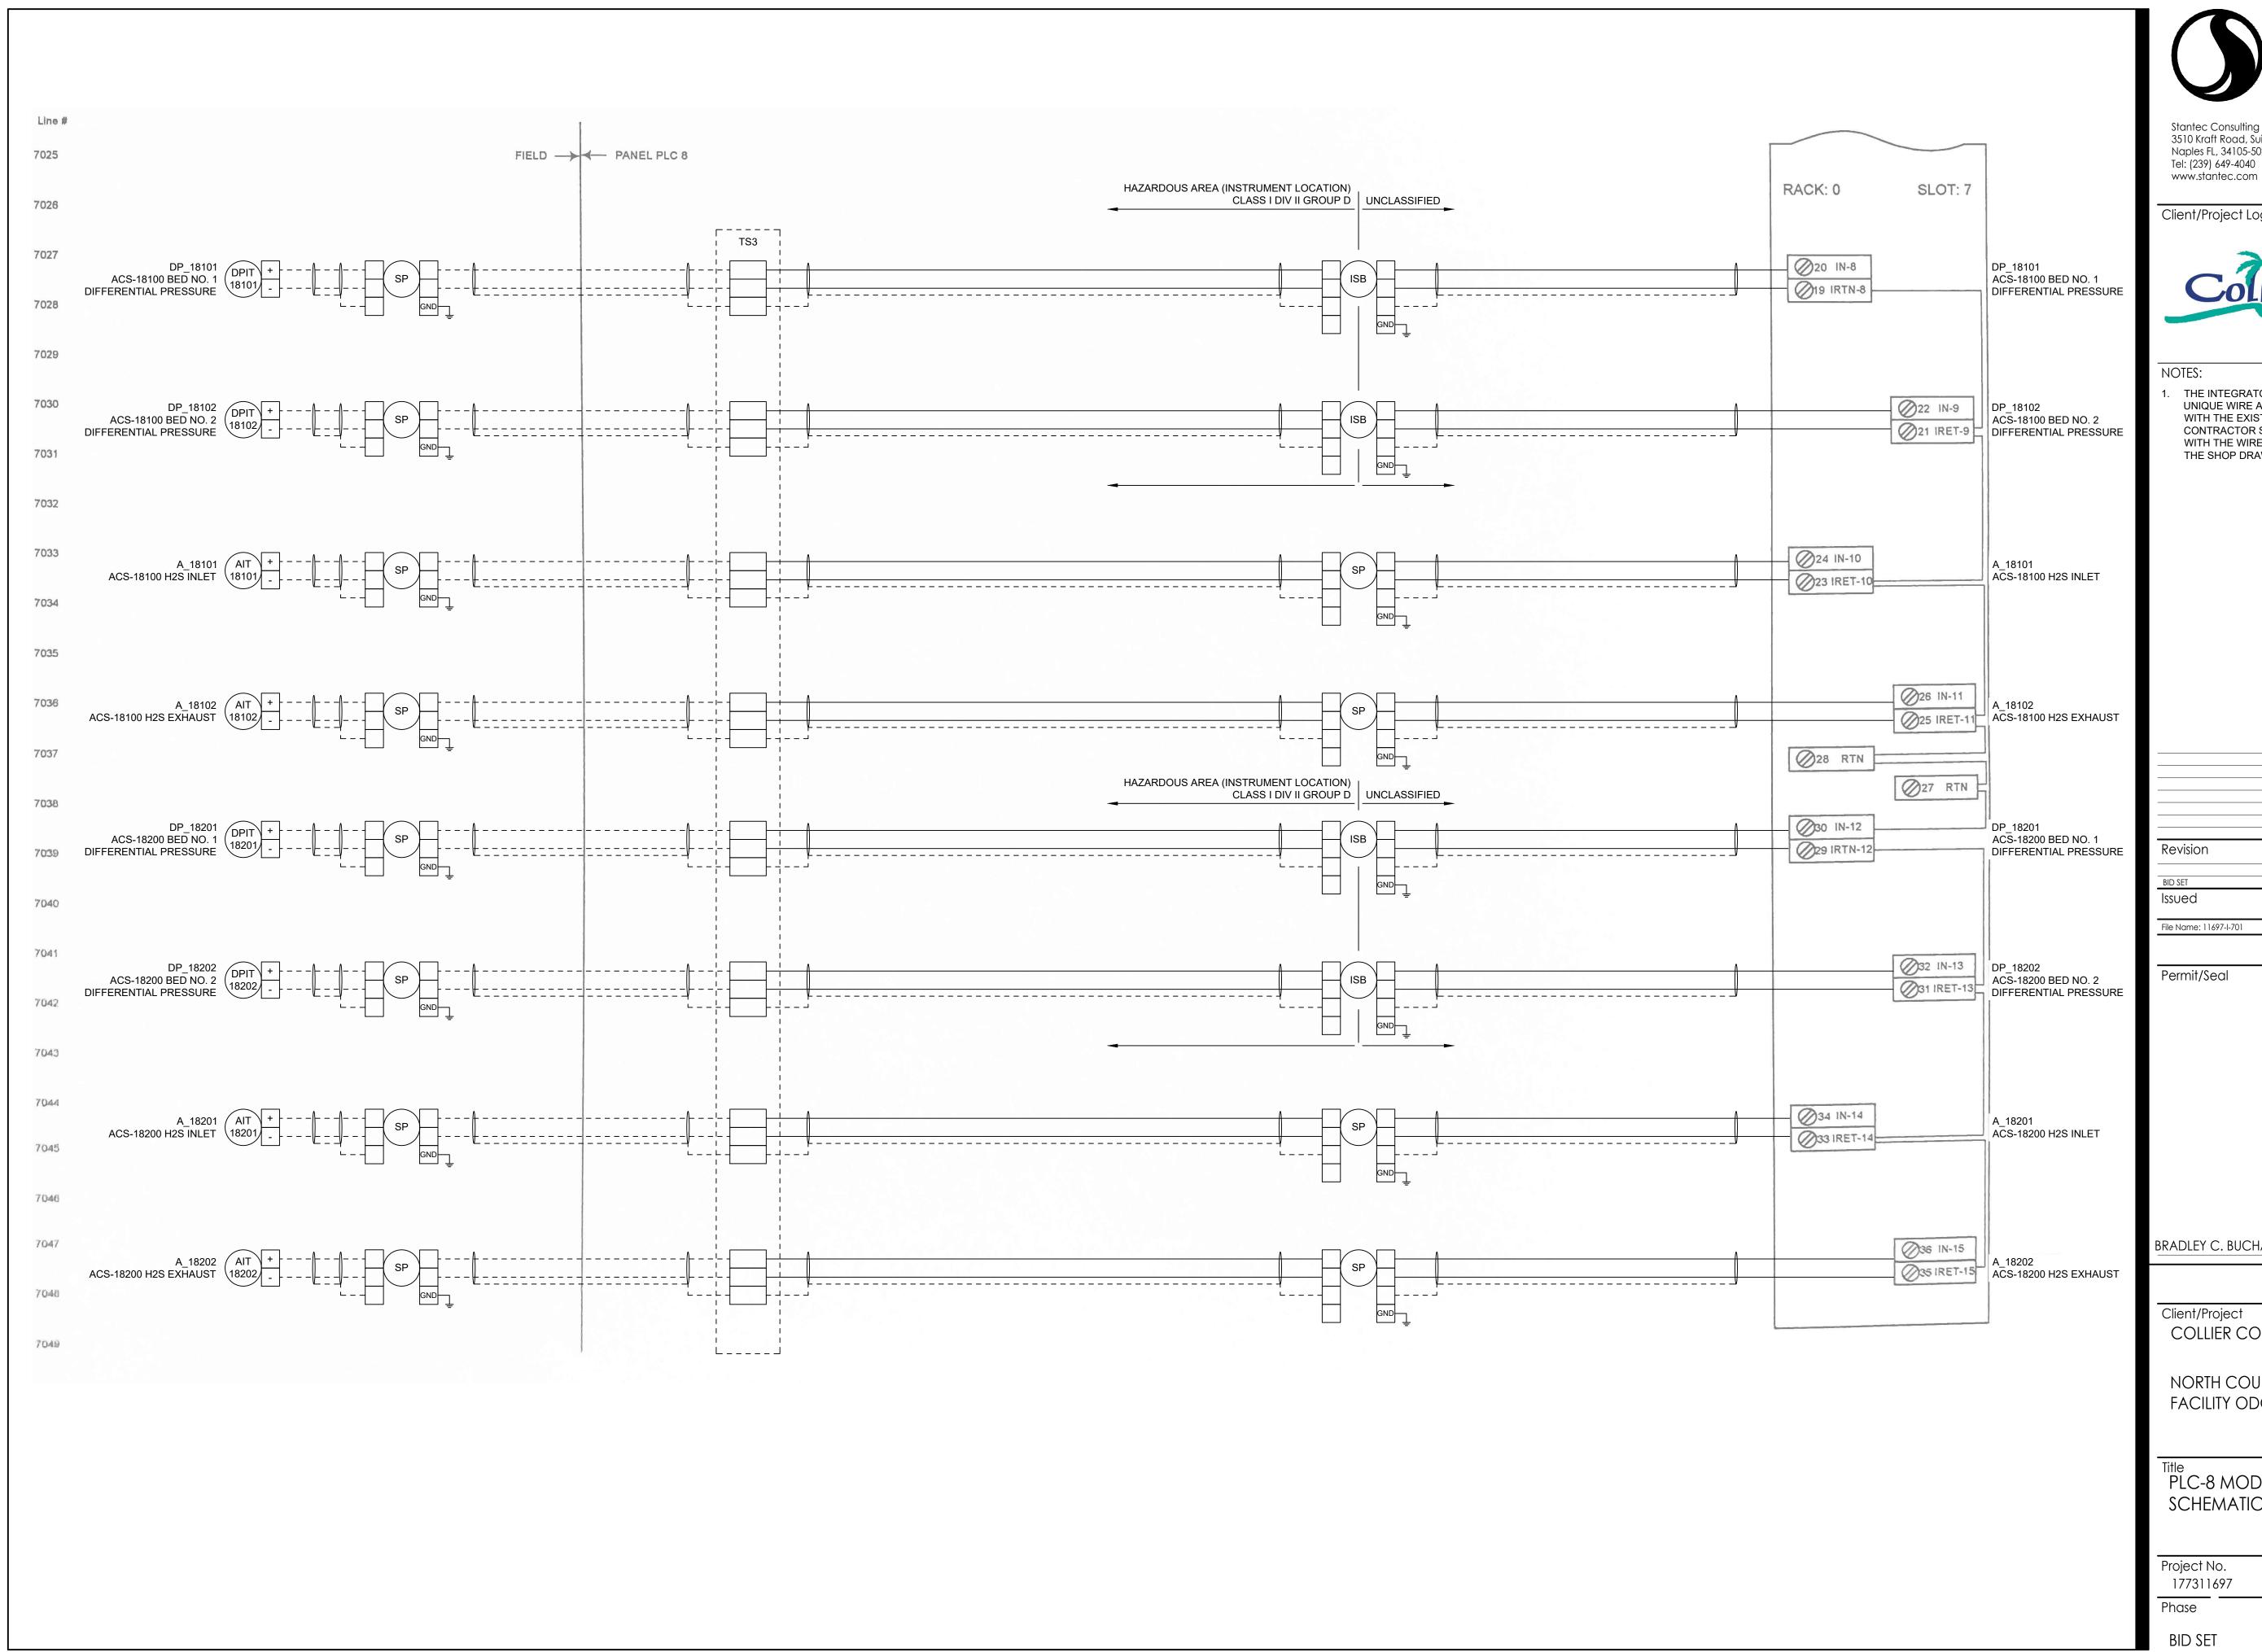COLLIER COUNTY PUBLIC UTILITIES

NORTH COUNTY WATER RECLAMATION FACILITY ODOR CONTROL - PHASE II

PLC-8 MODIFICATIONS SCHEMATIC - III

Scale NO SCALE Drawing No.

33 of 33

I-704